

Response and Development
Work Plan Addendum
Retail Area #2 – Flex Building

Area B: Sub-Parcel B6-2
Tradepoint Atlantic
Sparrows Point, Maryland

Prepared For:



TRADEPOINT ATLANTIC
1600 Sparrows Point Boulevard
Sparrows Point, Maryland 21219

Prepared By:



ARM GROUP LLC
9175 Guilford Road
Suite 310
Columbia, Maryland 21046

ARM Project No. 20010206

Respectfully Submitted,

A handwritten signature in black ink, appearing to read "Ryan Clancy".

Ryan Clancy, E.I.T.
Project Engineer

A handwritten signature in black ink, appearing to read "Neil Peters".

T. Neil Peters, P.E.
Senior Vice President

Revision 0 – July 8, 2021

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1.0 INTRODUCTION

1.1. BACKGROUND

ARM Group LLC (ARM), on behalf of Tradepoint Atlantic (TPA), has prepared this Response and Development Work Plan (RADWP) Addendum to facilitate the construction of a Flex Building designated as Retail Area #2. This retail lot is proposed for occupancy and use on Sub-Parcel B6-2 (the Site). The proposed layout of Retail Area #2 is shown on **Figure 1**.

Pursuant to Paragraph 3 of the First Amendment to the Administrative Consent Order (ACO), a cost comparison of the commercial environmental remediation costs against the originally budgeted industrial environmental cost estimate shall be performed. The estimated cost of the environmental oversight work to be performed by an Environmental Professional (EP) for Retail Area #2 is \$50,000. This cost is equivalent to the normal and customary cost for environmental oversight work performed on industrial parcels at Sparrows Point. The capping specifications and standards for this commercial development (building slab, concrete sidewalks, asphalts paving, clean capped landscaping) are the same as capping specifications and standards for an industrial parcel. Accordingly, there are no additional costs to the Budget based on commercial development and use; the semi-annual Budget review pursuant to Paragraph 84 of the ACO will continue to be conducted as required.

The construction and use of any retail lot at the Site must be approved by the Maryland Department of the Environment (MDE) and the United States Environmental Protection Agency (USEPA). The proposed major grading and utility installation tasks for the Site were covered by the agency-approved Sub-Parcel B6-2 RADWP (Revision 1 dated January 24, 2018).

The RADWP provided a Screening Level Risk Assessment (SLRA) for the entire Site to evaluate potential risks to Composite Workers and Construction Workers. The SLRA was recently updated to account for changes in the proposed boundary of the retail area, including the removal of the southern portion of the retail area originally proposed to the south of the Tin Mill Canal (TMC). The revised SLRA was presented in the Sub-Parcel B6-2 RADWP Addendum: SLRA Update dated June 28, 2021. The SLRA concluded that a capping remedy would adequately protect Composite Workers and site visitors from potential future exposures once the retail lots are occupied. The SLRA also determined the length of time that Construction Workers can perform ground intrusive work at the Site before site-specific health and safety measures may be needed for worker protection. This evaluation indicates that additional site-specific health and safety measures (beyond standard Level D protection) would be required only if an individual worker exceeded 40 exposure days of intrusive work.

1.2. OBJECTIVES

The RADWP specified that a brief Addendum detailing the site plan for each retail lot would be provided to the MDE and USEPA once the plans for each retail lot were finalized. The RADWP stated that the Addendum would need to include the layout of the proposed retail lot, along with an indication of the proposed final capping remedy. The objectives of this document are to allow the construction of the proposed retail lot at the Site, to allow occupancy prior to full implementation of the site-wide (Sub-Parcel B6-2) capping remedy, and to demonstrate that there are no concerns related to the proposed intrusive work schedule for Construction Workers.

2.0 RADWP ADDENDUM

2.1. REQUIREMENTS OF THE ADDENDUM

The Sub-Parcel B6-2 RADWP provides cross sections and specifications for all types of capping remedies which may be installed during the development of each retail lot, including requirements for any paved areas, landscaped areas, and/or stormwater ponds. The RADWP is the primary guidance document for all future development activities associated with the retail area. The RADWP established the following procedure to obtain agency approval to begin the construction of each individual retail lot:

Once plans for each retail lot are finalized, the MDE and USEPA will be provided with a brief RADWP Addendum detailing the site plan for the retail lot, along with an indication of the proposed final capping remedy, and a discussion of any concerns related to the intrusive work schedule (if any) associated with the construction of the applicable retail lot. Multiple retail lots may be combined into the same addendum if the sequencing of development is conducive to a single submission. The SLRA presented herein will serve as the primary reference document for any future development associated with Sub-Parcel B6-2, and addenda will be prepared and submitted to the agencies as necessary.

In addition, the proposed retail lot may be constructed and occupied prior to full implementation of the capping remedy which is required for the entire Site. The site-wide capping remedy throughout Sub-Parcel B6-2 is proposed to be installed using a phased approach as the individual retail lots are designed. To facilitate the use of the proposed retail lot, interim measures could be required for some retail lots to protect workers and visitors, as outlined in the RADWP as follows:

Depending on occupancy opportunities prior to the completion of all retail development phases, access restrictions or other mechanisms will be used to prevent potential exposures to uncapped portions of the Composite Worker Area during the interim period to temporarily prevent potential exposures until the required capping remedy is fully implemented. With these temporary restrictions, the Composite Worker and child/youth visitors will not be exposed to potentially impacted soils while commercial activities are being conducted on (completed) capped portions of the Site. If occupancy of the Site is proposed prior to full implementation of the capping remedy for the Composite Worker Area, a detailed RADWP Addendum must be submitted to the agencies and approved prior to use. The RADWP Addendum would need to include details of the proposed interim measures including locations and protocols for the installation and maintenance of the proposed remedy. The interim measures could include temporary access restrictions (e.g., fencing) and/or temporary capping mechanisms (e.g., crushed concrete), among other possible responses.

There are no interim remedies to be installed for Retail Area #2. The development area will be fully capped by surface engineering controls, and a permanent perimeter fence will be installed along the perimeter as more fully described in Section 2.2.2.

2.2. RETAIL AREA #2

2.2.1. General Development Protocols

The construction of the retail lot will remain subject to all development implementation protocols outlined in the Sub-Parcel B6-2 RADWP (Revision 1 dated January 24, 2018) and RADWP Addendum: SLRA Update (dated June 28, 2021), including but not limited to the following:

- Development activities will be conducted under the property-wide Health and Safety Plan (HASP) and all ground intrusive work will be performed in accordance with the modified Level D Personal Protective Equipment (PPE) requirements outlined in the property-wide Sparrows Point Development PPE Standard Operational Procedure (SOP).
- Oversight will be provided by an EP during permanent cap installation, as well as all intrusive construction activities.
- Soil screening requirements will be implemented as required.
- Erosion and sediment controls will be installed as required.
- Dust monitoring will be implemented as required.
- If dewatering is necessary, sampling and disposal will be conducted as required.
- The NAPL Contingency Plan will be implemented as required.
- Utility backfill materials must be approved by the MDE Voluntary Cleanup Program (VCP). MDE VCP clean fill approved for commercial land use will be required at depths and alignments where the utility trench could be considered to be part of a landscaped cap (i.e., depths less than or equal to 2 feet). Slag or other approved backfill soil not meeting the MDE VCP definition of clean fill may be used in areas where the utility trench will be covered by an additional cap.

Due to the known presence of NAPL along the proposed western access driveway in the vicinity of historical soil boring B6-066-SB, utility alignments and invert elevations must be considered with respect to these impacts prior to trenching. Soil screening will be especially important during any excavation of existing soil in these areas. Observations and delineation results for NAPL in the vicinity of the western access driveway are detailed in the NAPL Delineation Completion Report for B6-066-PZ (Revision 0 dated April 14, 2020) and related Comment Response Letter dated March 26, 2021.

2.2.2. Proposed Layout and Capping Remedy

Development drawings for the proposed retail lot are provided in **Appendix A**. As indicated in the drawings, the proposed retail lot will include a 62,000 square-foot Flex Building. The retail lot will be capped by paved driveways and parking areas, paved building slab, and landscaped

areas between the paved areas. The proposed cap areas and types are shown on **Figure 2**. All of the cross sections for each type of proposed capping remedy will be required to meet the minimum thicknesses given in the Sub-Parcel B6-2 RADWP.

A permanent perimeter fence will be installed along the majority of the perimeter to prevent access to other areas of Sub-Parcel B6-2 that are not covered by this plan. The approximate alignment of the perimeter fence is shown on **Figure 2**, although the alignment may be subject to minor modification. The perimeter fence will prevent access to uncapped portions of Sub-Parcel B6-2 while additional retail lots are being designed and constructed. The perimeter fence will enclose the northern and western perimeters of Retail Area #2 (with the exception of the western end of the access road which extends across a BGE utility easement; the fence cannot be installed across the easement) and will also run along the TMC at the southern perimeter of the Retail Area #2. A perimeter fence will not be installed along the eastern perimeter of the Retail Area #2 where it adjoins with existing paved roadways and other previously developed retail areas (the Marketing Center and Royal Farms).

Driveways will be constructed to allow access to and from the retail lot. As indicated in the site plan drawing provided in **Appendix A**, paved drives are currently proposed along several alignments within the lease boundary, with primary access at the eastern and southwestern ends of the retail lot. The paved drives will also be subject to the minimum cap thicknesses given in the Sub-Parcel B6-2 RADWP. Areas within the Retail Area #2 boundary not covered by asphalt, building slab, or concrete will be considered landscaped areas and will consist of a minimum of 2 feet of clean fill (meeting VCP requirements for commercial land use) prior to being planted. Trees will be installed with a minimum of 2 feet of clean fill (meeting VCP requirements for commercial land use) around the root ball. A geotextile marker fabric will be placed between the clean backfill and underlying soils. Tradepoint Atlantic is proposing to use the Mirafi[®] 140N nonwoven geotextile (or equal) as the preferred marker fabric for this development project. This product has been accepted but was not originally specified as a preferred material within the Sub-Parcel B6-2 RADWP. A product sheet for this fabric is included as **Appendix B**.

The major utility trenching and installation tasks were conducted under the scope of work described in the Sub-Parcel B6-2 RADWP. However, as shown in the site plan drawing in **Appendix A**, additional utilities and tie-ins will be installed under this Addendum.

2.2.3. Construction Worker Ground Intrusive Work

As indicated in the site plan drawing provided in **Appendix A**, additional utilities and tie-ins will be installed under this Addendum. Ground intrusive activities which could result in potential Construction Worker exposures are expected to be limited primarily to utility installation tasks performed by specific crews. The revised SLRA presented in the Sub-Parcel B6-2 RADWP Addendum: SLRA Update dated June 28, 2021 indicated that an exposure duration of 40 days did not result in any potentially unacceptable risk or hazard for Construction Workers.

As a conservatism and protective measure, during all development work on the TPA property Construction Workers performing ground intrusive work will adhere to the upgraded PPE requirements outlined in the property-wide Sparrows Point Development PPE SOP. The PPE SOP was created after the submission of the Sub-Parcel B6-2 RADWP but was attached to the Sub-Parcel B6-2 RADWP Addendum: SLRA Update dated June 28, 2021. The approved modified Level D PPE requirements, including specific PPE details, planning, tracking/supervision, enforcement, and documentation, are outlined in the PPE SOP.

3.0 REPORTING AND IMPLEMENTATION SCHEDULE


A Development Completion Report and Notice of Completion of Remedial Actions will be prepared following construction of each proposed retail lot. The Development Completion Report will summarize the completed capping activities and installation of the perimeter fence.

The proposed implementation schedule is provided below.

<u>Task</u>	<u>Proposed Completion Date</u>
Anticipated RADWP Addendum Approval	August 1, 2021
Installation of Erosion and Sediment Controls	October 1, 2021
Utility Installation	December 1, 2021
Permanent Capping Remedy Installation	February 2, 2022
Submittal of Completion Report/ Notice of Completion of Remedial Actions*	June 1, 2022

*Notice of Completion of Remedial Actions shall be prepared by Professional Engineer registered in Maryland and submitted with the Development Completion Report to certify that the work is consistent with the requirements of this RADWP Addendum and the retail lot is suitable for occupancy.

FIGURES

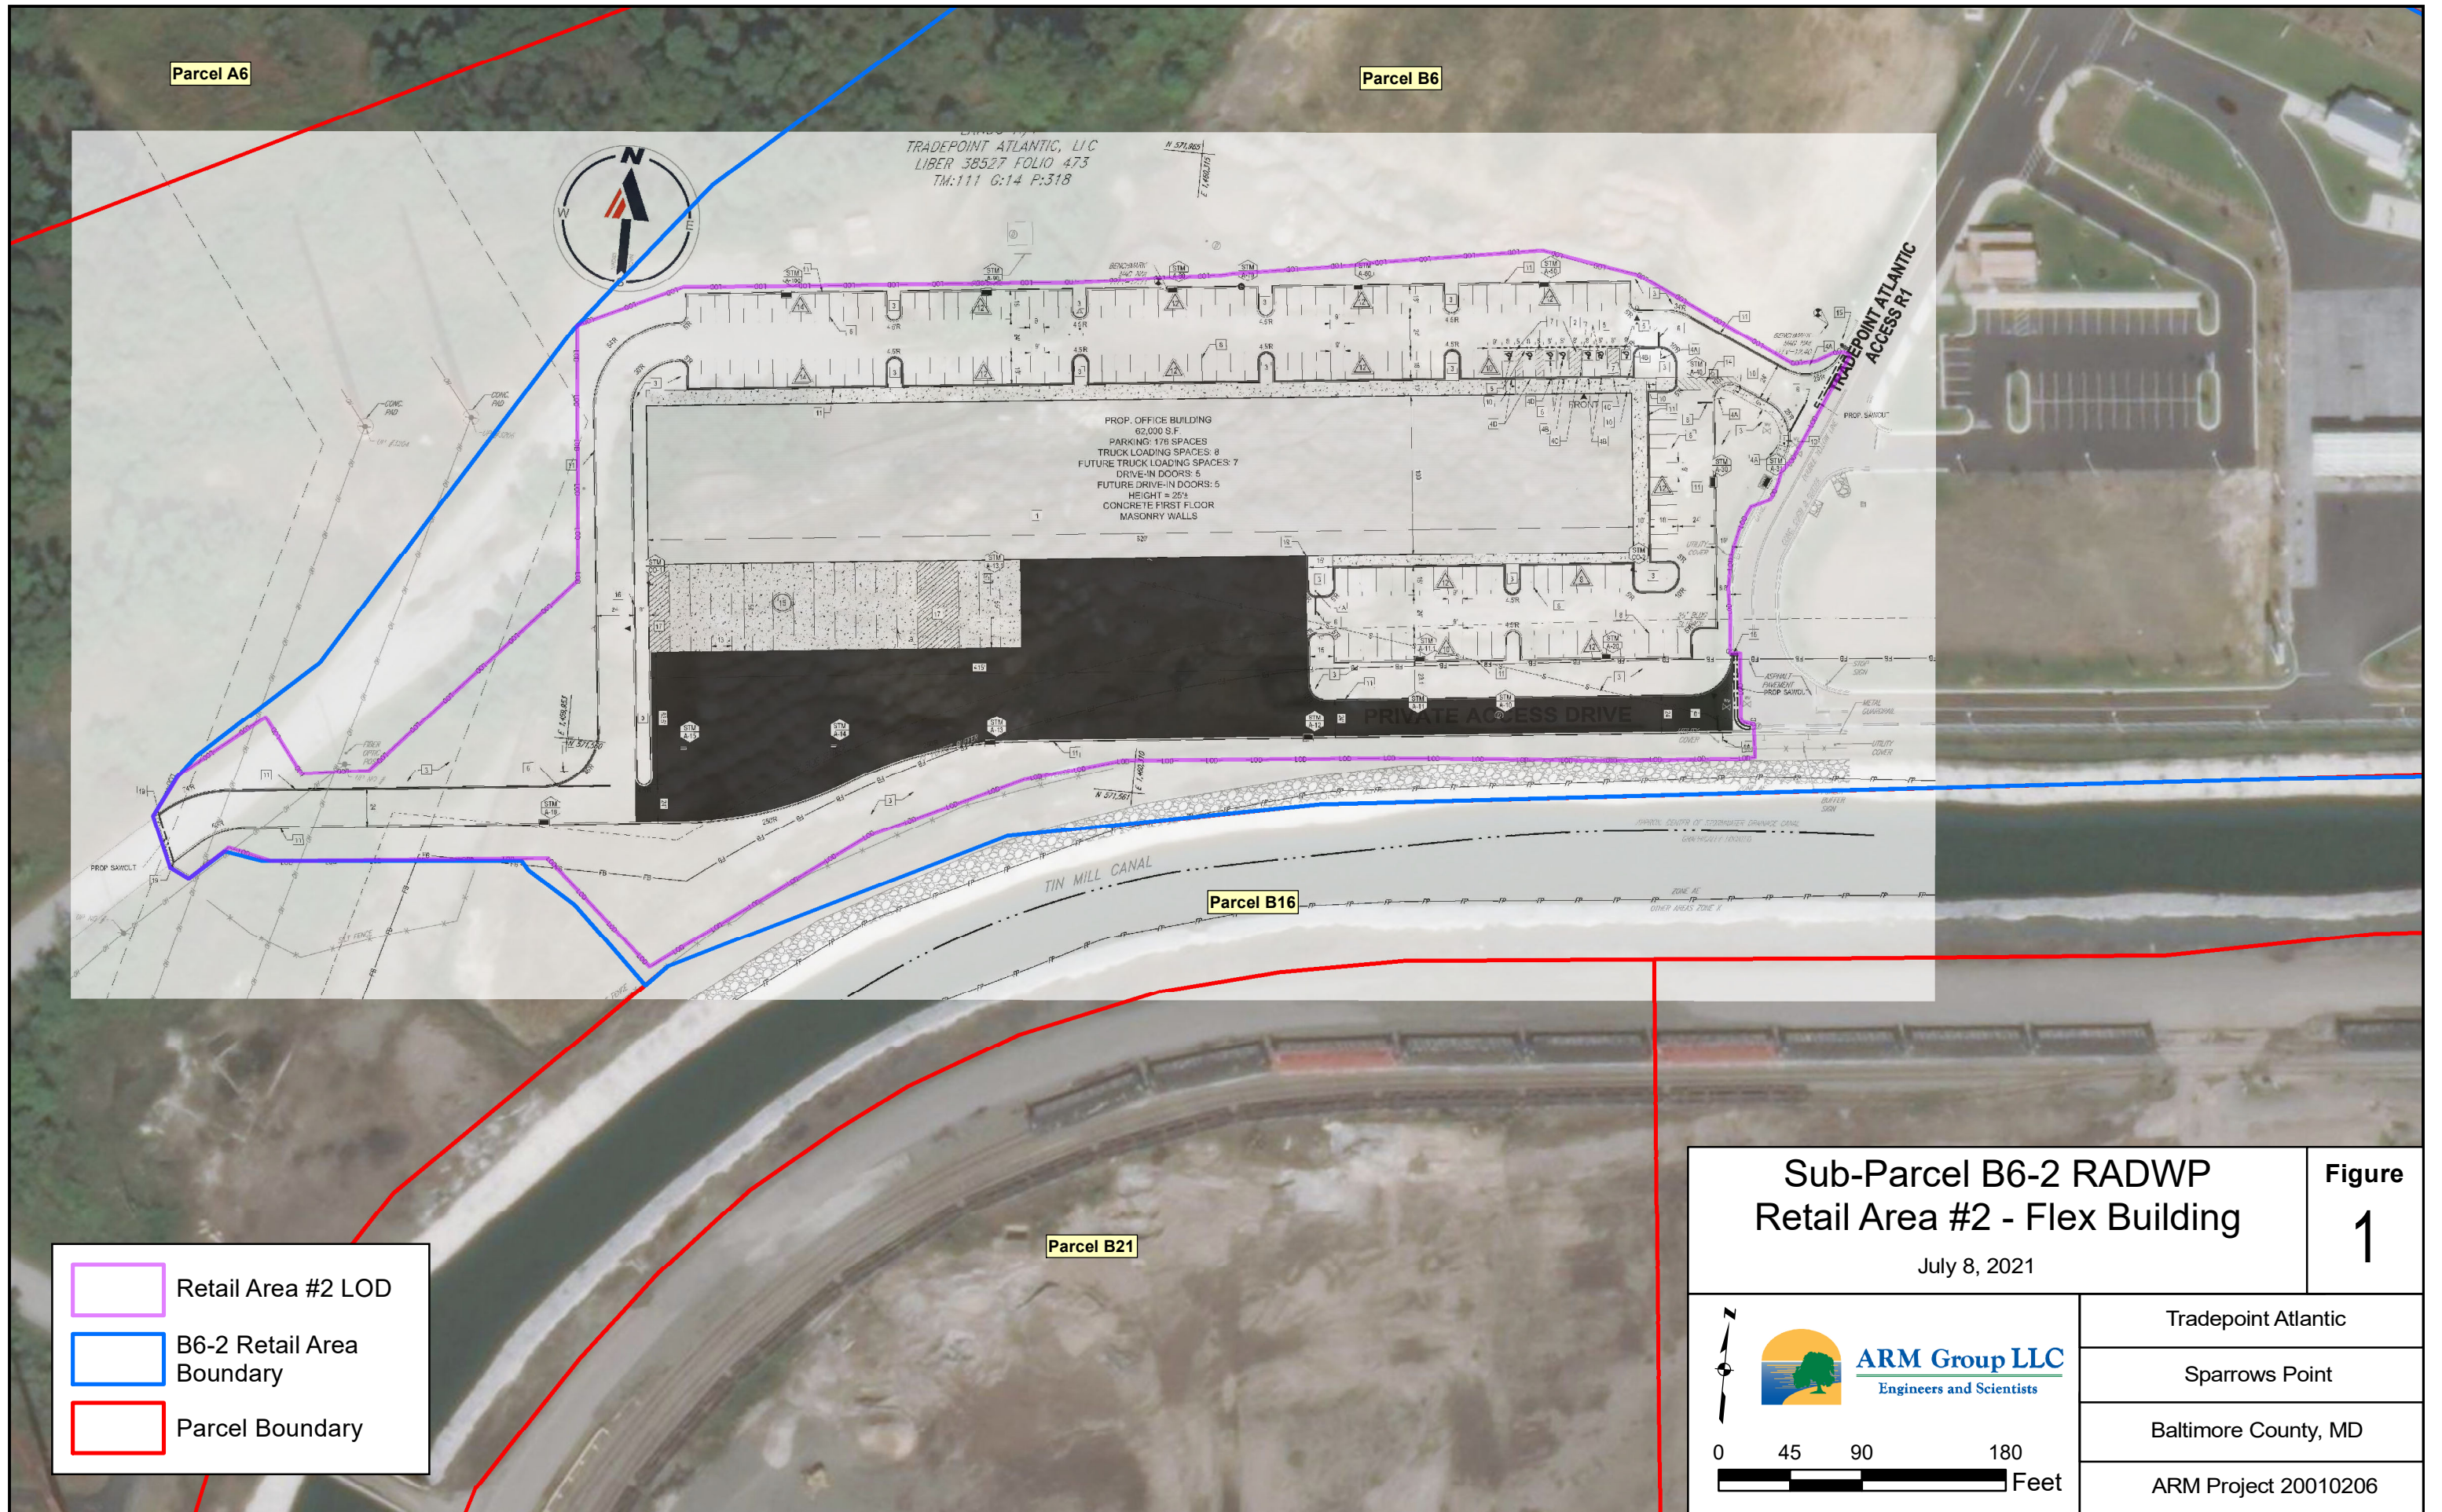

TRADEPOINT ATLANTIC, LLC
 LIBER 38527 FOLIO 473
 TM:111 G:14 P:318


PROP. OFFICE BUILDING
 62,000 S.F.
 PARKING: 178 SPACES
 TRUCK LOADING SPACES: 8
 FUTURE TRUCK LOADING SPACES: 7
 DRIVE-IN DOORS: 5
 FUTURE DRIVE-IN DOORS: 5
 HEIGHT = 26'
 CONCRETE FIRST FLOOR
 MASONRY WALLS

Parcel B16

Parcel B21

- Retail Area #2 LOD
- B6-2 Retail Area Boundary
- Parcel Boundary

<h3>Sub-Parcel B6-2 RADWP Retail Area #2 - Flex Building</h3> <p>July 8, 2021</p>		Figure 1
<p>ARM Group LLC Engineers and Scientists</p>	Tradepoint Atlantic	
	Sparrows Point	
	Baltimore County, MD	
	ARM Project 20010206	

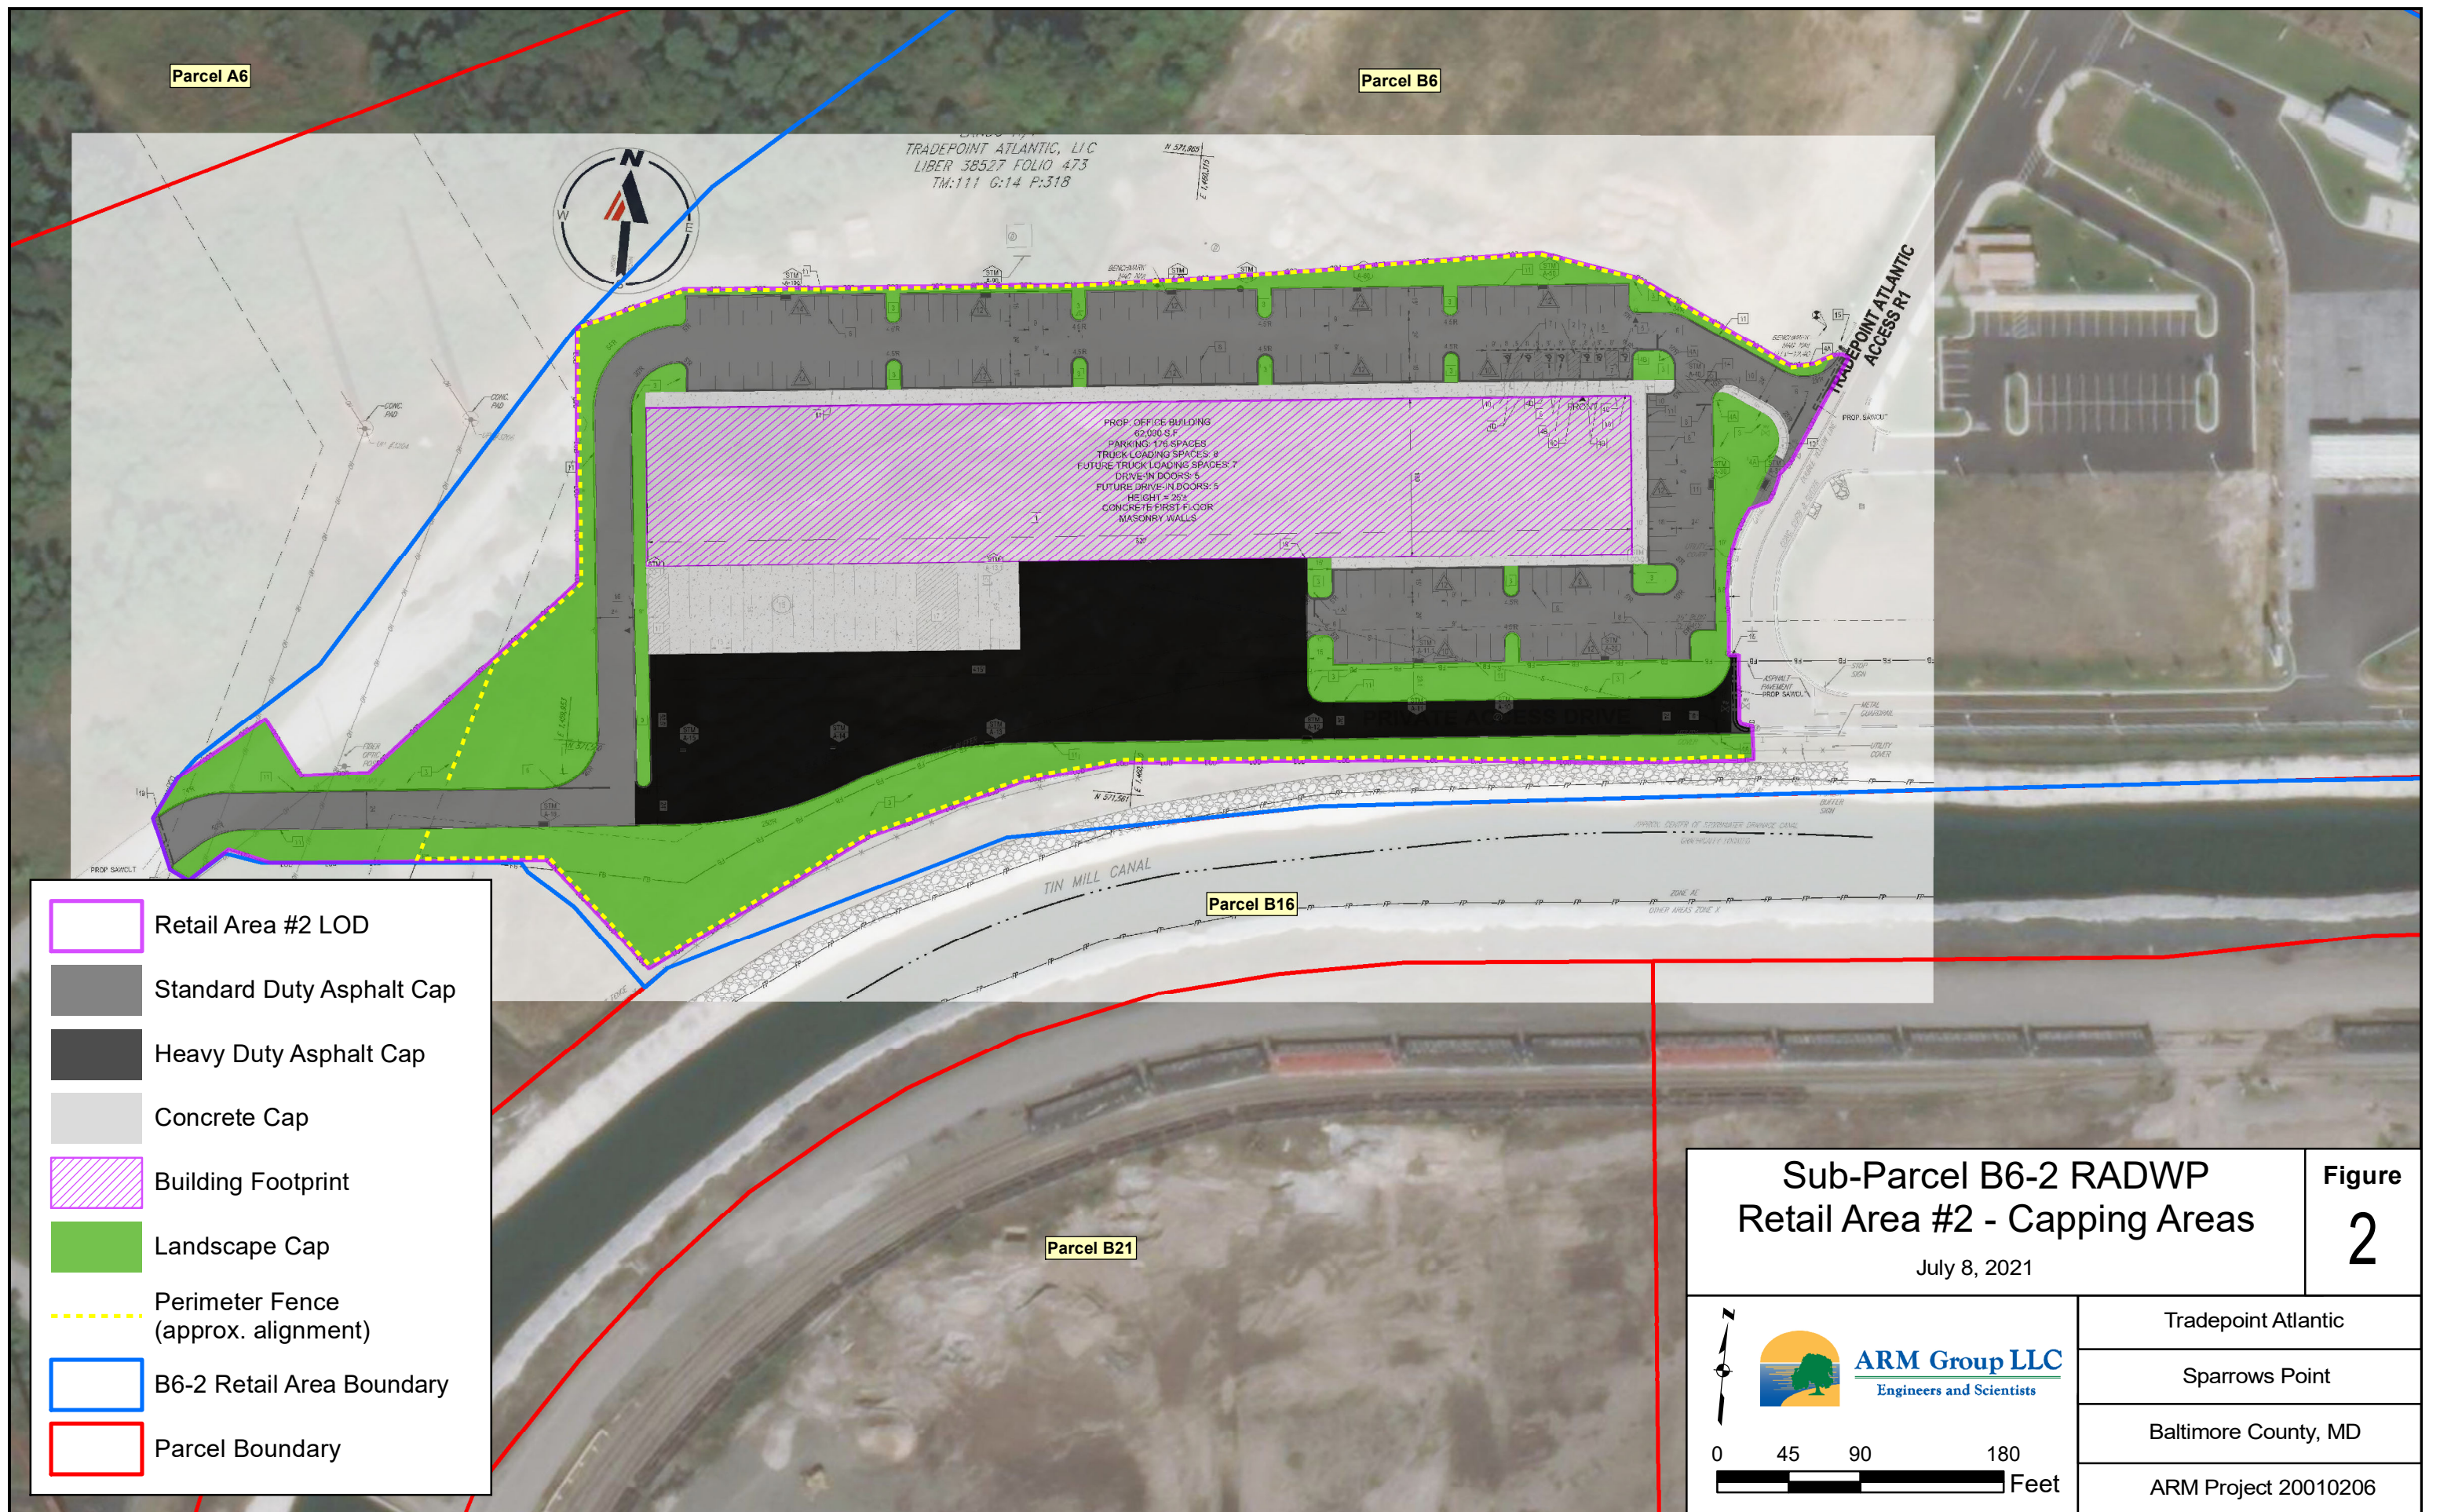

- Retail Area #2 LOD
- Standard Duty Asphalt Cap
- Heavy Duty Asphalt Cap
- Concrete Cap
- Building Footprint
- Landscape Cap
- Perimeter Fence (approx. alignment)
- B6-2 Retail Area Boundary
- Parcel Boundary

<h3>Sub-Parcel B6-2 RADWP Retail Area #2 - Capping Areas</h3> <p>July 8, 2021</p>		Figure 2
<p>ARM Group LLC Engineers and Scientists</p>	Tradepoint Atlantic	
	Sparrows Point	
	Baltimore County, MD	
	ARM Project 20010206	

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APPENDIX A

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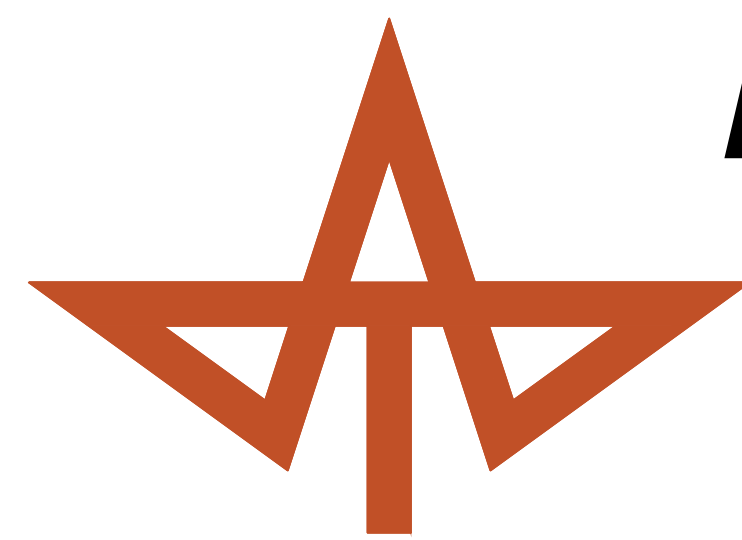
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STANDARD DRAWING LEGEND FOR ENTIRE PLAN SET. Table with columns for LIMIT OF WORK, LIMIT OF DISTURBANCE, EXISTING NOTE, TYPICAL NOTE TEXT, PROPOSED NOTE, and various symbols for utilities, structures, and features.


STANDARD ABBREVIATIONS FOR ENTIRE PLAN SET. Table listing abbreviations and their corresponding full names, such as AC (ACRES), ADA (AMERICANS WITH DISABILITY ACT), ARCH (ARCHITECTURAL), etc.

PROPOSED FLEX BUILDING



FOR TRADEPOINT ATLANTIC PHASE II PLANS

LOCATION OF SITE
6995 BETHLEHEM BOULEVARD
BALTIMORE, MD 21219
TM 111, GRID 14, PARCEL 318
ELECTION DISTRICT 15
COUNCILMANIC DISTRICT 7
BALTIMORE COUNTY

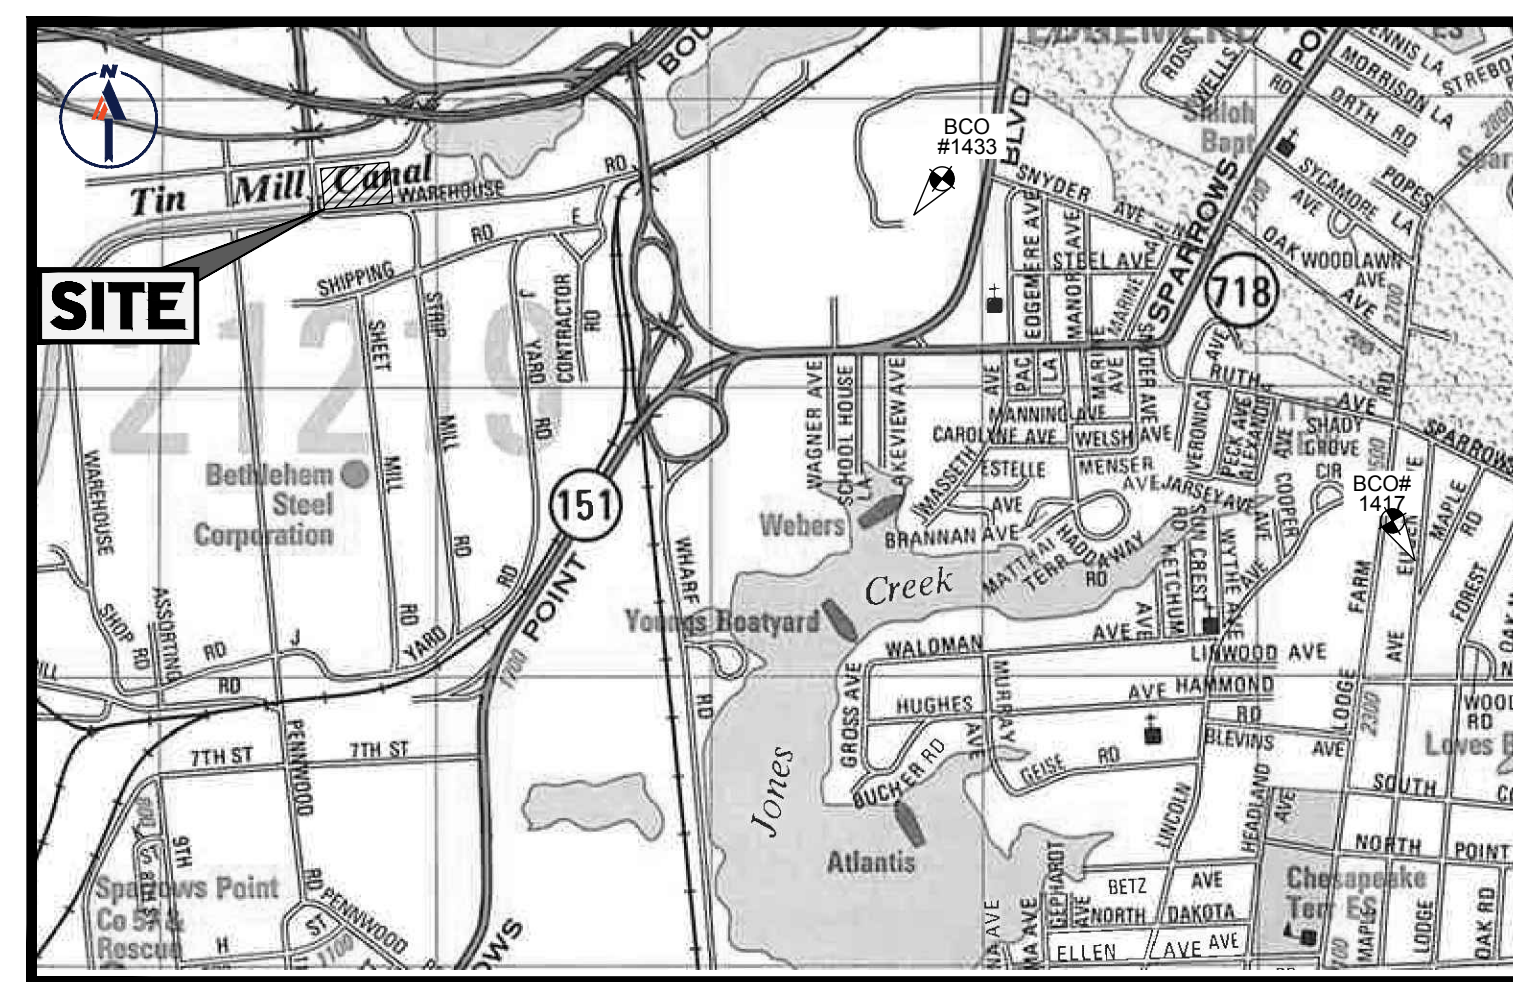


LOCATION MAP
COPYRIGHT ADO THE MAP PEOPLE
PERMIT USE NO. 20602153-5
SCALE: 1"=2000'

BENCHMARK INFORMATION

ELEVATIONS ARE BASED ON NAVD 88, COORDINATES AND MERIDIAN ARE BASED ON THE MARYLAND COORDINATE SYSTEM (MCS) PER THE FOLLOWING MONUMENTS:

- BC0# 1433 (CAPPED REBAR)
N 571.683.79, E 1.466.230.69, ELEV. 16.59
IN MEDIUM OF NORTH POINT BLVD SOUTH OF NORTH SNYDER AVE.
- BC0# 1417 (MAG SPIKE)
N 569.885.10, E 1.469.030.75, ELEV. 14.11
EAST SIDE OF LODGE FARM ROAD
SOUTH OF LINCOLN AVE.

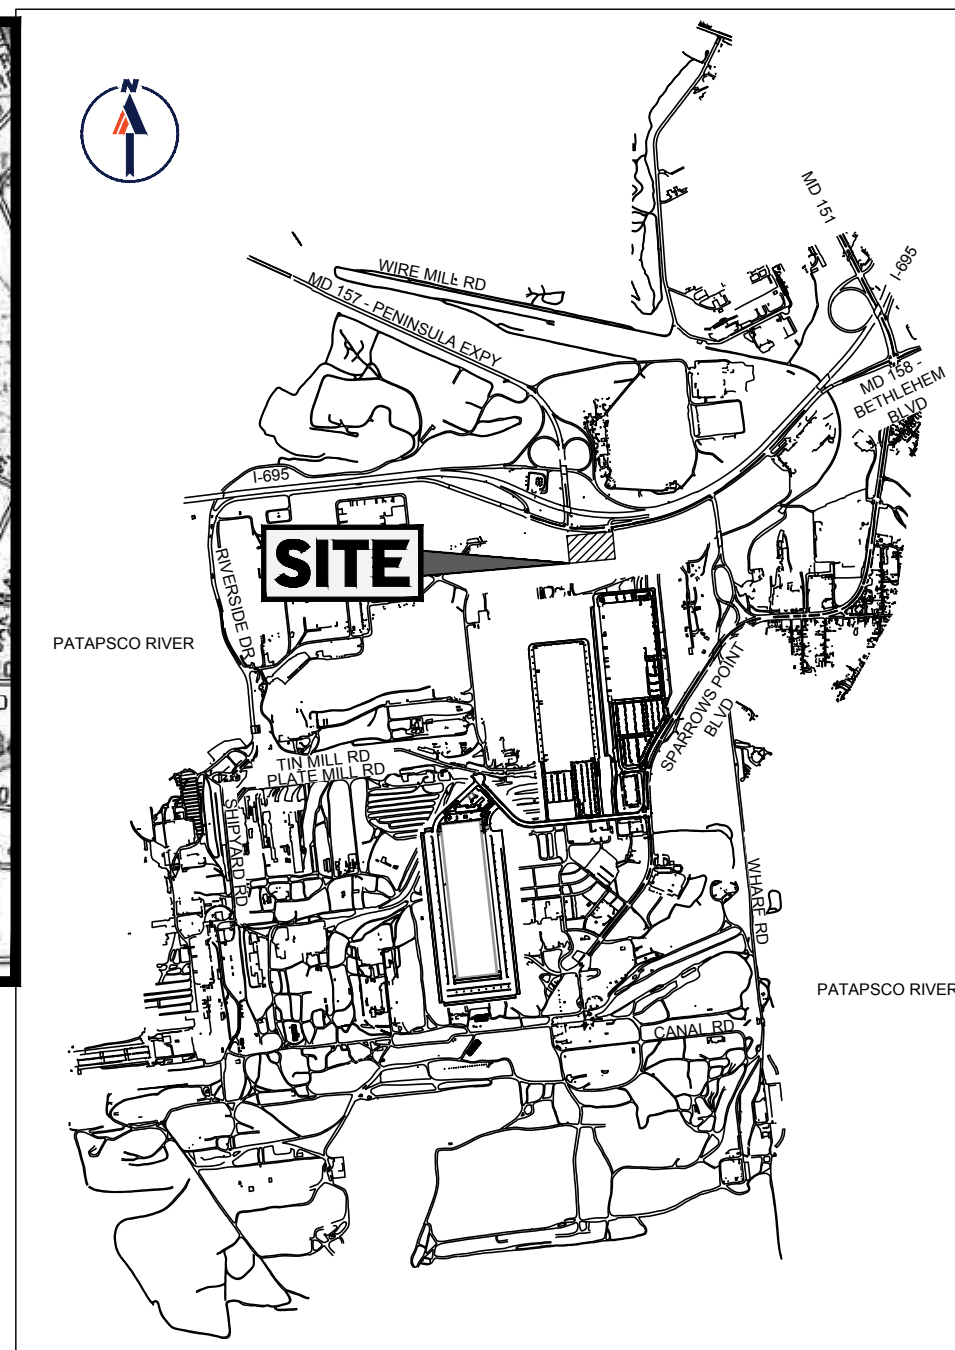

VICINITY MAP
SCALE: 1"=3000'

PREPARED BY



CONTACT: MICHAEL J. GESELL, P.E.

GENERAL NOTE: IT IS THE RESPONSIBILITY OF THE CONTRACTOR TO REVIEW ALL OF THE DRAWINGS AND SPECIFICATIONS ASSOCIATED WITH THIS PROJECT WORK SCOPE PRIOR TO THE INTRATION OF CONSTRUCTION. SHOULD THE CONTRACTOR FIND A CONFLICT WITH THE DOCUMENTS RELATIVE TO THE SPECIFICATIONS OR APPLICABLE CODES, IT IS THE CONTRACTOR'S RESPONSIBILITY TO NOTIFY THE PROJECT ENGINEER OF RECORD IN WRITING PRIOR TO THE START OF CONSTRUCTION. FAILURE BY THE CONTRACTOR TO NOTIFY THE PROJECT ENGINEER SHALL CONSTITUTE ACCEPTANCE OF FULL RESPONSIBILITY BY THE CONTRACTOR TO COMPLETE THE SCOPE OF THE WORK AS DENIED BY THE DRAWINGS AND IN FULL ACCORDANCE WITH ALL LOCAL, STATE AND FEDERAL LAWS AND REGULATIONS.

REFERENCES: EXISTING CONDITIONS, SURVEY, GAS AND ELECTRIC, STORM DRAIN, UTILITY CONTACTS.

GOVERNING AGENCIES: BALTIMORE COUNTY DEPARTMENT OF PUBLIC WORKS, MARYLAND DEPARTMENT OF THE ENVIRONMENT, BALTIMORE COUNTY DEPARTMENT OF ENVIRONMENTAL PROTECTION AND SUSTAINABILITY, BALTIMORE COUNTY DEPARTMENT OF DEVELOPMENT MANAGEMENT.

SHEET INDEX table listing SHEET TITLE and SHEET NUMBER for various plan components like COVER SHEET, GENERAL NOTES, EXISTING CONDITIONS, etc.

OWNER/DEVELOPER
TRADEPOINT DEVELOPMENT, LLC
1600 SPARROWS POINT BLVD
BALTIMORE, MD 21219
CONTACT: MICHAEL BARRY
PHONE: 443-648-5070

OWNER'S/DEVELOPER'S CERTIFICATION: I/WE HEREBY CERTIFY THAT ANY CLEARING, GRADING, CONSTRUCTION AND/OR DEVELOPMENT WILL BE DONE PURSUANT TO THIS PLAN AND THAT ANY RESPONSIBLE PERSONNEL INVOLVED IN THIS CONSTRUCTION PROJECT WILL HAVE A CERTIFICATE OF ATTENDANCE AT A MARYLAND DEPARTMENT OF THE ENVIRONMENT APPROVED TRAINING PROGRAM FOR THE CONTROL OF SEDIMENT AND EROSION BEFORE BEGINNING THE PROJECT.

SIGNATURE OWNER/DEVELOPER: _____ DATE: _____
SIGNATURE CONSULTANT: _____ DATE: _____
MICHAEL J. GESELL, PE 44097
PRINT NAME: _____ MD LICENSE NUMBER: _____

ISSUED FOR CONSTRUCTION stamp with signature lines for OWNER/DEVELOPER and CONSULTANT, project number, revision date, and date.



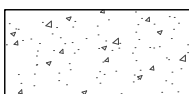

BOHLER logo and contact information: BOHLER ENGINEERING, SITE CIVIL AND CONSULTING ENGINEERING, PROGRAM MANAGEMENT, LANDSCAPE ARCHITECTURE, SUSTAINABLE DESIGN, PERMITTING SERVICES, TRANSPORTATION SERVICES.

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NOT APPROVED FOR CONSTRUCTION stamp. PROJECT: FLEX BUILDING FOR TRADEPOINT ATLANTIC. ADDRESS: 6995 BETHLEHEM BOULEVARD, BALTIMORE, MD 21219.

BOHLER logo and M.J. GESELL stamp: PROFESSIONAL ENGINEER, MARYLAND LICENSE NO. 44097. SHEET TITLE: COVER SHEET. SHEET NUMBER: C-101. DATE: 3/19/2021.

LEGEND

-  STANDARD DUTY ASPHALT PAVEMENT
-  HEAVY DUTY ASPHALT PAVEMENT
-  CONCRETE SIDEWALK
-  HEAVY DUTY CONCRETE PAVEMENT

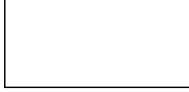SITE KEYNOTES


- 1 SITE CONTRACTOR SHALL REFER TO ARCHITECTURAL PLANS FOR THE EXACT DIMENSIONS OF THE BUILDING AND THE LOCATION OF DOORWAYS, UTILITIES, ETC.
 - 2 DEPRESSED CURB AND GUTTER
 - 3 LANDSCAPED AREA
 - 4 TRAFFIC SIGNAGE
- ALL SIGNS SHALL CONFORM TO THE "MANUAL ON UNIFORM TRAFFIC CONTROL DEVICES" (MUTCD) BY THE U.S. DEPARTMENT OF TRANSPORTATION.
- 4A "STOP" SIGN (R1-1)
 - 4B BOLLARD MOUNTED ADA ACCESSIBLE PARKING SIGNAGE (WITH VAN ACCESSIBLE SIGNAGE)
 - 4C BOLLARD MOUNTED "NO PARKING IN ACCESS AISLE" SIGNAGE
 - 4D BOLLARD MOUNTED ADA ACCESSIBLE PARKING SIGNAGE
- 5 ADA PARKING SYMBOL (WHITE SYMBOL WITH BLUE BACKGROUND)
 - 6 24" WHITE PAINTED STOP BAR
 - 7 4" WHITE PAVEMENT MARKING, 45° ANGLE, 2" O.C.
 - 8 4" WHITE PARKING STALL PAVEMENT MARKING (9x18" TYP.)
 - 9 4" SINGLE SOLID YELLOW PAVEMENT MARKING (TYP.)
 - 10 ACCESSIBLE CURB RAMP
 - 11 6" CURB W/ 1.5" GUTTER
 - 12 SITE LIGHT (REFER TO PHOTOMETRIC PLANS)
 - 13 LOADING DOCK DOOR (TYP.) (REFER TO ARCHITECTURAL PLANS)
 - 14 CROSSWALK - 12" WHITE PAVEMENT MARK, 45° ANGLE 4" O.C.
 - 15 RELOCATED SITE LIGHT

- 16 6" HEADER CURB
- 17 4" YELLOW PAVEMENT PARKING, 45° ANGLE, 2" O.C.
- 18 METAL STAIRS (REFER TO ARCHITECTURAL PLANS)
- 19 6" CURB TAPER

SITE NOTES

1. TOTAL SITE AREA: 132,225,998 S.F. OR 3,035.49 AC.
2. PROPERTY SITE AREA: 1132,225,998 S.F. OR 3,035.49 AC.
3. PROPOSED FLOOR AREA: 62,000 S.F.
4. DEED REFERENCE: LIBER 35478, FOLIO 379
5. ELECTION DISTRICT: 15TH
6. COUNCILMANIC DISTRICT: 7TH
7. TAX MAP 111, GRID 14, PARCEL 318
8. TAX. ACCT. NOS.: 1502024000
9. OWNER: TRADEPOINT DEVELOPMENT, LLC, 1600 SPARROWS POINT BLVD, BALTIMORE, MD 21219
10. DEVELOPER/APPLICANT: TRADEPOINT DEVELOPMENT, LLC, 1600 SPARROWS POINT BLVD, BALTIMORE, MD 21219
11. ZONE: MH-IM (MANUFACTURING - HEAVY - INDUSTRIAL - MAJOR)
12. PREVIOUS ZONING CASES: NONE
13. WATERSHED: BALTIMORE HARBOR
14. CENSUS TRACT: 9800.00
15. ALL SOILS ARE URBAN LAND, UDORTHENTS, 0 TO 8% SLOPES
16. EXISTING USE: VACANT
17. PROPOSED USE: FLEX BUILDING
18. PARKING REQUIRED: OFFICE: 3.3 PER 1,000 SF FLOOR AREA = 165 SPACES; WAREHOUSE: 1 SPACE PER EMPLOYEE = 11 SPACES
 - PROVIDED: 176 SPACES
 - INCLUDING 7 ADA SPACES
19. STRUCTURE HEIGHT
 - REQUIRED: UNLIMITED
 - PROPOSED: 25±
20. THIS SITE IS SERVED BY PUBLIC WATER AND SEWER SYSTEMS.
21. THERE ARE NO KNOWN WELLS OR SEPTIC SYSTEMS LOCATED WITHIN THE PROPOSED DEVELOPMENT AREA.

LANDS N/F
TRADEPOINT ATLANTIC, LLC
LIBER 38527 FOLIO 473
TM:111 G:14 P:318

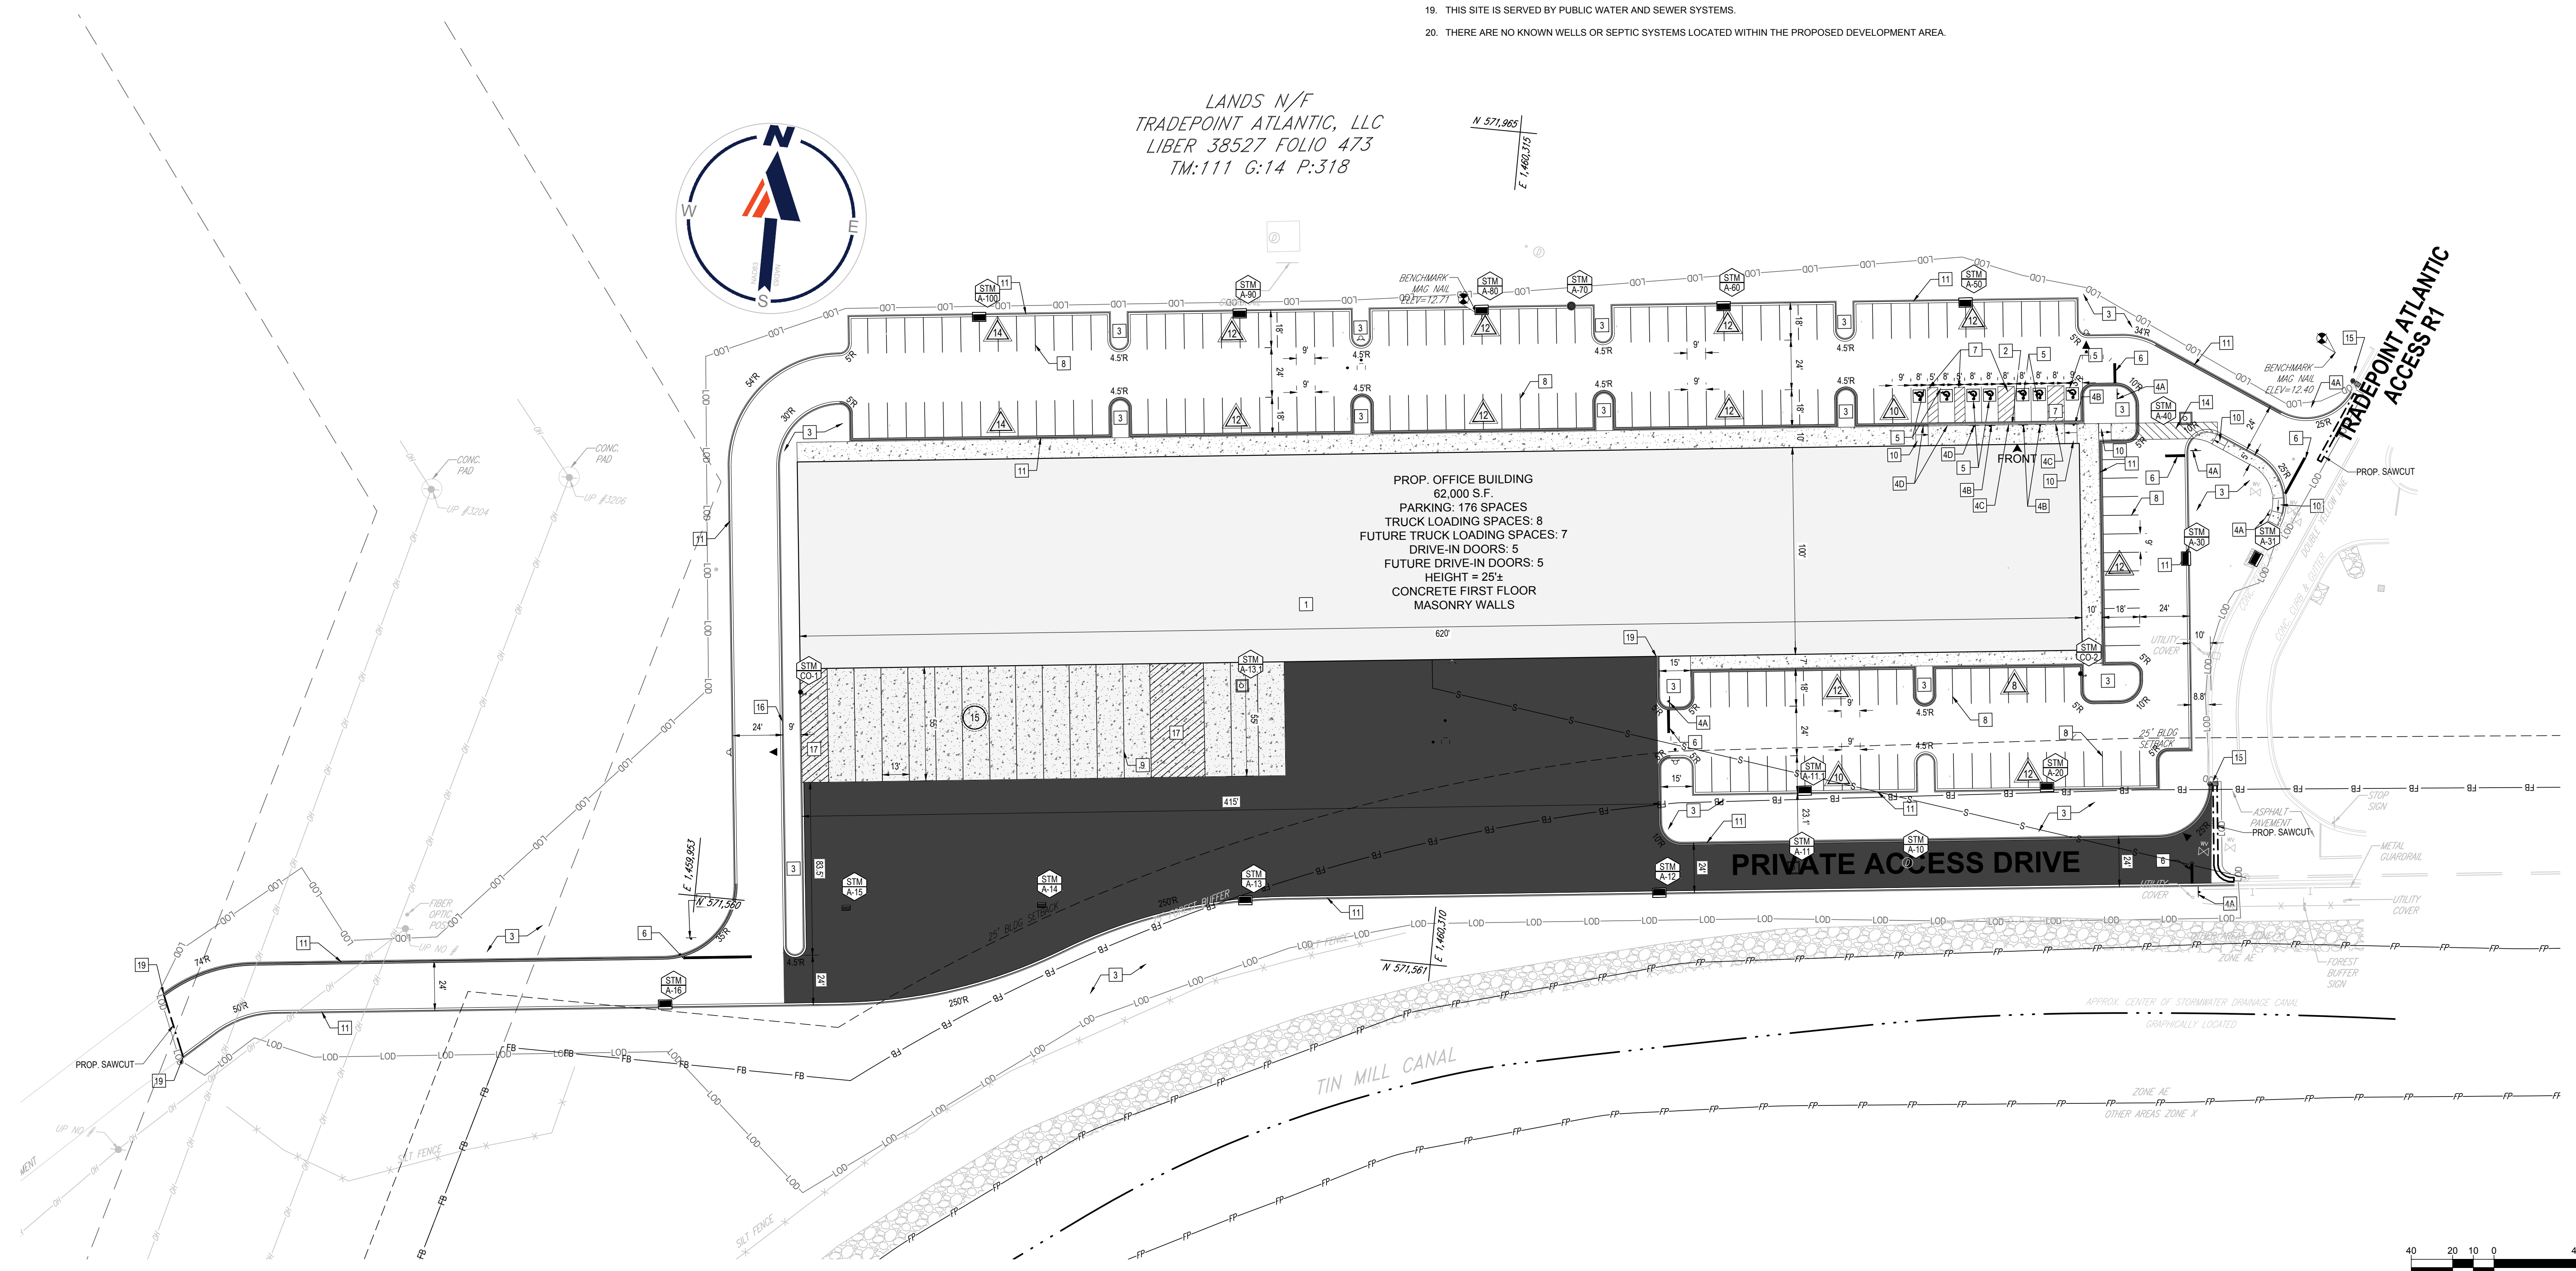

BOHLER
SITE CIVIL AND CONSULTING ENGINEERING
PROGRAM MANAGEMENT
LANDSCAPE ARCHITECTURE
SUSTAINABLE DESIGN
PERMITTING SERVICES
TRANSPORTATION SERVICES

REVISIONS

REV	DATE	COMMENT	DRAWN BY	CHECKED BY

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PROJECT NO.: MD16206636
DRAWN BY: JHS
DATE: 3/19/2021
CAD ID: MD16206636-SPP-0

FLEX BUILDING

FOR

TRADEPOINT ATLANTIC

6995 BETHLEHEM BOULEVARD
BALTIMORE, MD 21219
TM 111, GRID 14, PARCEL 318
ELECTION DISTRICT 15
COUNCILMANIC DISTRICT 7
BALTIMORE COUNTY

BOHLER

901 DULANEY VALLEY ROAD, SUITE 801
TOWSON, MARYLAND 21204
Phone: (410) 821-7900
Fax: (410) 821-7987
MD@BohlerEng.com


M.J. GESELL

PROFESSIONAL ENGINEER
MARYLAND LICENSE NO. 44097
PROFESSIONAL CERTIFICATION
I, MICHAEL J. GESELL, HEREBY CERTIFY THAT THESE DOCUMENTS WERE PREPARED OR APPROVED BY ME, AND THAT I AM A DULY LICENSED PROFESSIONAL ENGINEER UNDER THE LAWS OF THE STATE OF MARYLAND. LICENSE NO. 44097, EXPIRATION DATE: 6/30/21

SHEET TITLE:
SITE PLAN

SHEET NUMBER:
C-301

ORG. DATE - 3/19/2021

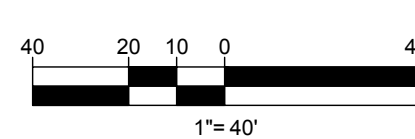

H:\16MD16206636\DRAWINGS\PLAN SETS\CONSTRUCTION DOCUMENTS\MD16206636-SPP-0-LAYOUT-C-001-SITE PLAN.dwg

REVISIONS

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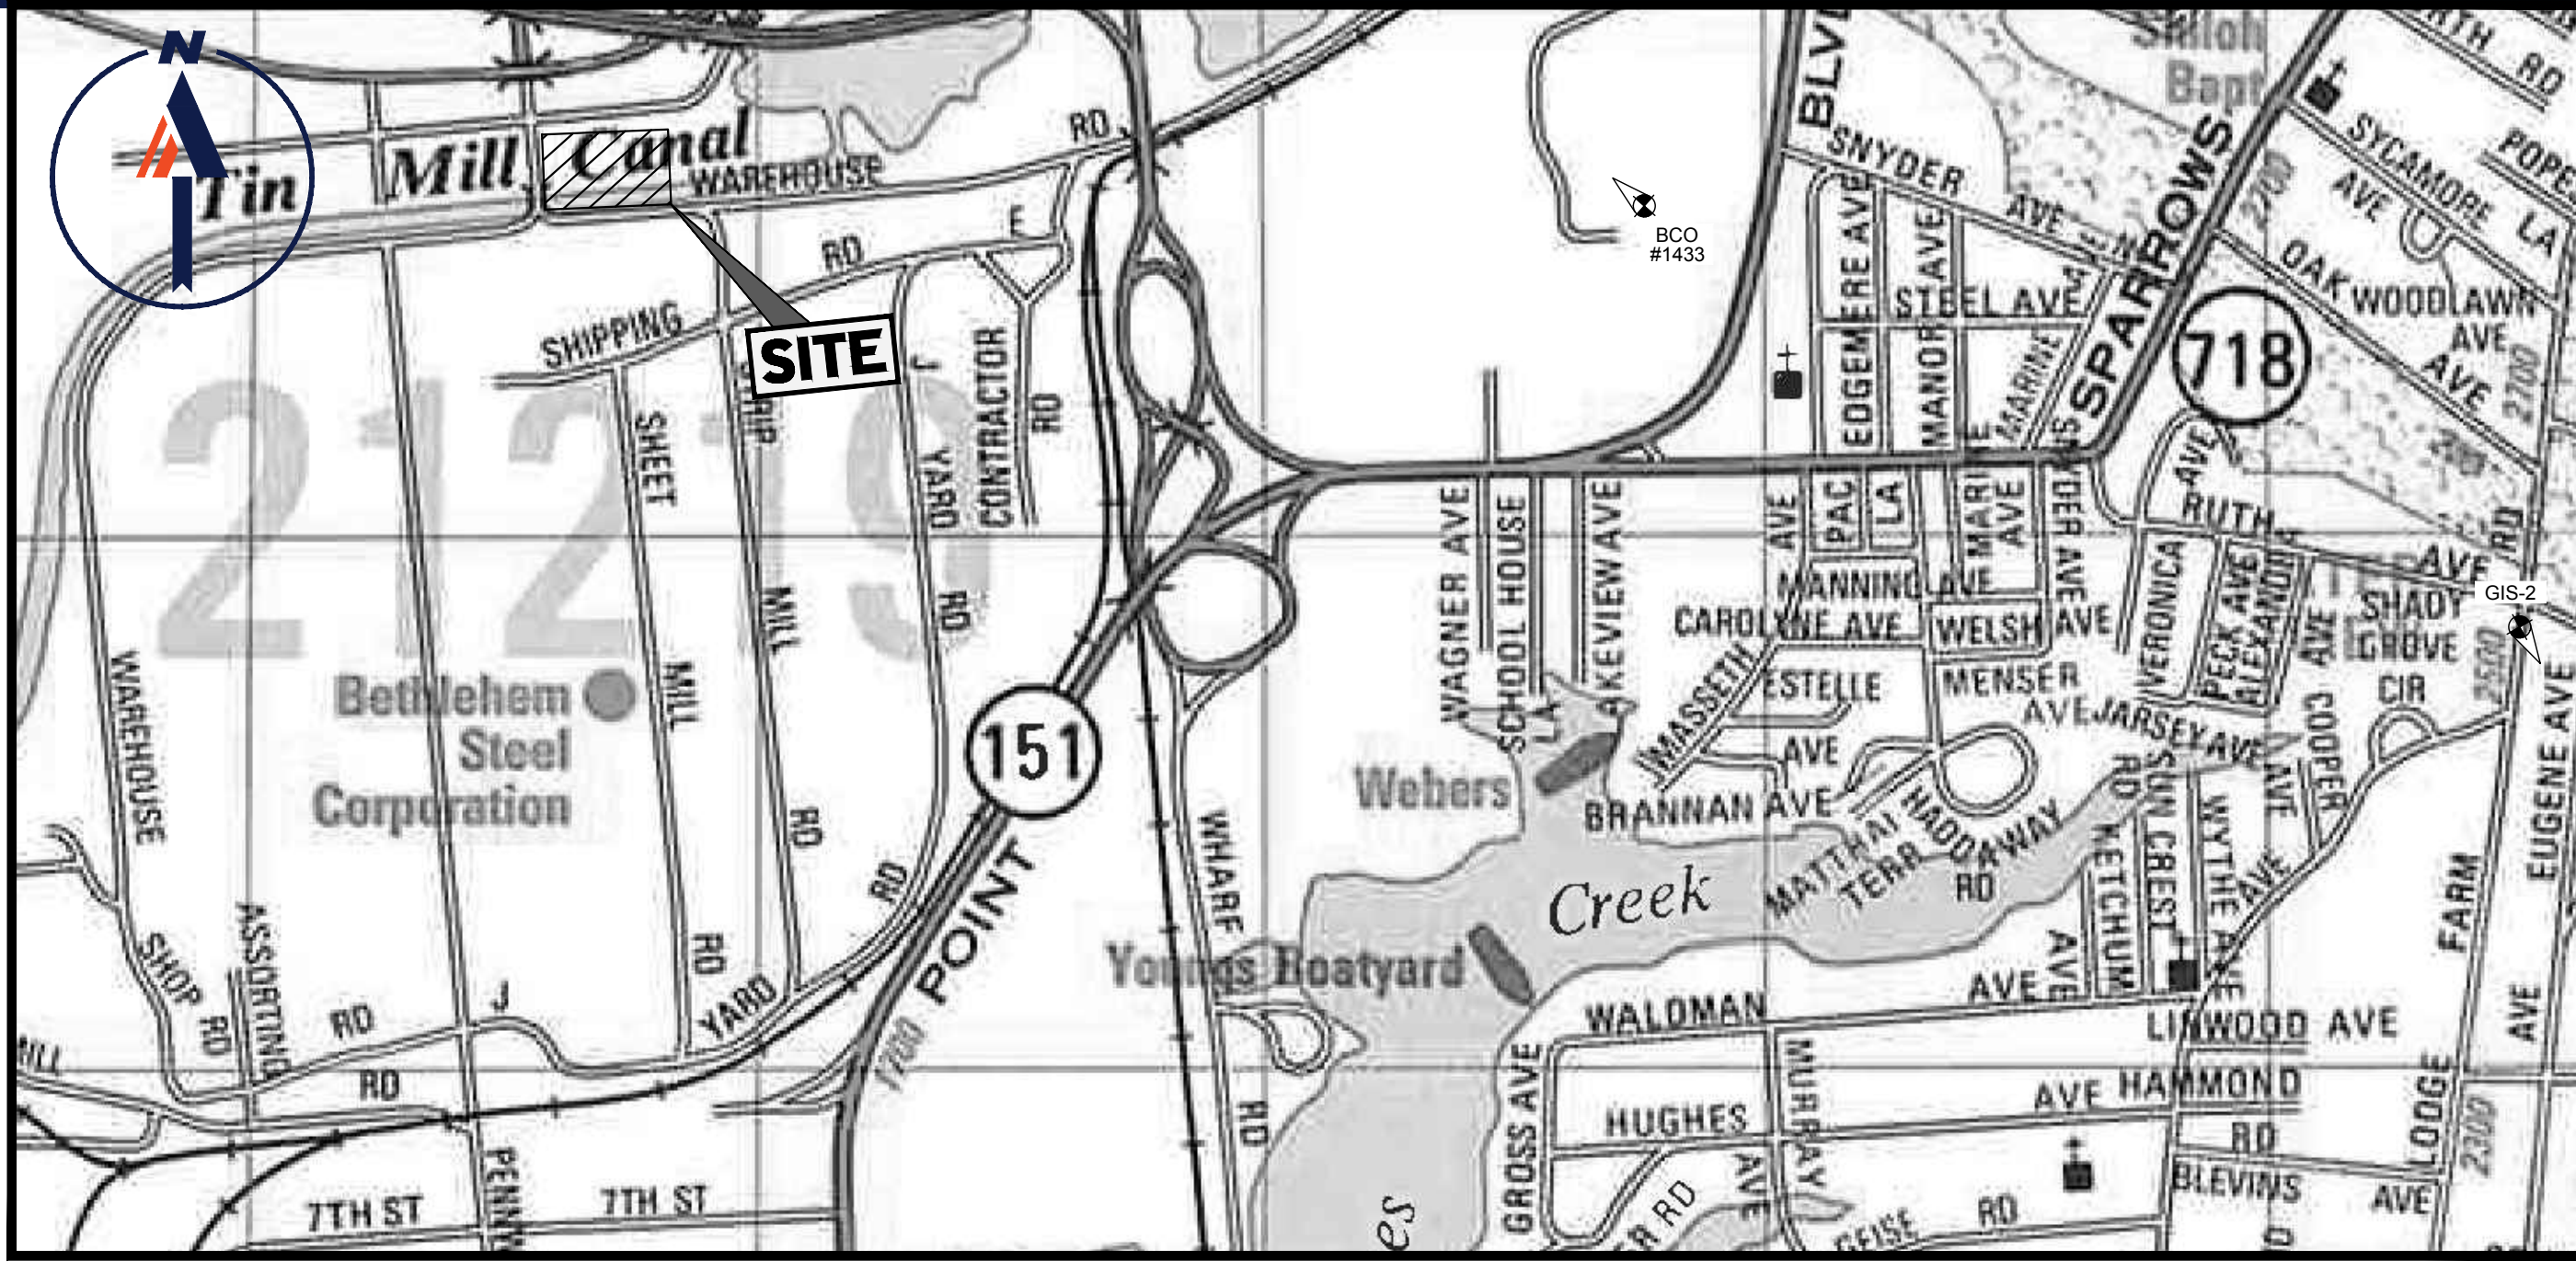
PROJECT No.: MD1620636
 DRAWN BY: JHS
 CHECKED BY: MUG
 DATE: 3/19/2021
 CAD ID: MD1620636-SPF-0

FLEX BUILDING
 FOR
TRADEPOINT ATLANTIC
 6995 BETHLEHEM BOULEVARD
 BALTIMORE, MD 21219
 TM 111, GRID 14, PARCEL 318
 ELECTION DISTRICT 15
 COUNCILMANIC DISTRICT 7
 BALTIMORE COUNTY

BOHLER
 901 DULANEY VALLEY ROAD, SUITE 801
 TOWSON, MARYLAND 21204
 Phone: (410) 821-7900
 Fax: (410) 821-7987
 MD@BohlerEng.com

M.J. GESELL
 PROFESSIONAL ENGINEER
 MARYLAND LICENSE NO. 4497
 I, MICHAEL J. GESELL, HEREBY CERTIFY THAT THESE DOCUMENTS WERE PREPARED OR APPROVED BY ME, AND THAT I AM A DULY LICENSED PROFESSIONAL ENGINEER UNDER THE LAWS OF THE STATE OF MARYLAND. LICENSE NO. 4497, EXPIRATION DATE: 6/30/21

FINAL GRADING PLAN
 SHEET NUMBER:
C-401
 ORG. DATE - 3/19/2021



LOCATION MAP
 COPYRIGHT ADC THE MAP PEOPLE
 PERMIT USE NO. 20602153-5
 SCALE: 1"=100'

BENCHMARK INFORMATION
 ELEVATIONS ARE BASED ON NAVD 88. COORDINATES AND MERIDIAN ARE BASED ON THE MARYLAND COORDINATE SYSTEM (MCS) PER THE FOLLOWING MONUMENTS:
 BCOM 1433 (CAPPED REBAR)
 N 571.683.79, E 1.466.230.69, ELEV. 16.59
 IN MEDIAN OF NORTH POINT BLVD SOUTH OF NORTH SNYDER AVE.
 BCOM 1417 (NAG SPIKE)
 N 569.695.10, E 1.469.030.75, ELEV. 14.11
 EAST SIDE OF LODGE FARM ROAD SOUTH OF LINCOLN AVE

- SITE SPECIFIC GRADING NOTES**
- ALL UTILITIES SHOWN ARE PRIVATE UNLESS OTHERWISE NOTED.
 - THE SUBJECT DEVELOPMENT AREA IS LOCATED IN FLOOD ZONE 'X' (AREAS DETERMINED TO BE OUTSIDE THE 0.2% ANNUAL CHANCE FLOODPLAIN) PER MAP ENTITLED "NATIONAL FLOOD INSURANCE PROGRAM, FIRM, FLOOD INSURANCE RATE MAP, BALTIMORE COUNTY, MARYLAND (UNINCORPORATED AREAS) PANEL 555 OF 580", MAP NUMBER 240010555G, MAP REVISED MAY 5, 2014, AND PLAN PREPARED BY PAI, DEVS. PLAN REVIEW, DATED SEPTEMBER 21, 2016, PER MAP 0555F, DATED SEPTEMBER 26, 2008
 - ADDITIONAL EXISTING UTILITIES AND SITE FEATURES LOCATED WITHIN THE LIMIT OF DISTURBANCE NOT IDENTIFIED AS "TO BE REMOVED" OR "TO BE RELOCATED" MAY REQUIRE REMOVAL OR RELOCATION AS DIRECTED BY THE GEOTECHNICAL ENGINEER OR TRADEPOINT DEVELOPMENT.
 - EXISTING UTILITIES NOTED AS "TO REMAIN" WITHIN THE LIMIT OF DISTURBANCE MUST BE MAINTAINED TO PROVIDE SERVICE FOR THE PROPOSED DEVELOPMENT.
 - EXISTING GRADES SHOWN ON THIS PLAN ARE FROM THE APPROVED MASS GRADING PLANS. IF ACTUAL EXISTING GRADES DIFFER FROM WHAT IS SHOWN ON THESE PLANS, CONTRACTOR IS TO NOTIFY BOHLER IN WRITING.
 - EXISTING MAN-HOLE, CLEANOUT, AND VALVE COVERS WITHIN THE LIMIT OF DISTURBANCE NOT IDENTIFIED AS "TO BE REMOVED" ARE TO BE ADJUSTED TO MEET FINAL GRADES.
 - LOCATION OF ALL UNDERGROUND UTILITIES ARE APPROXIMATE. SOURCE INFORMATION FROM PLANS AND MARKINGS HAVE BEEN COMBINED WITH OBSERVED EVIDENCE OF UTILITIES TO DEVELOP A VIEW OF THOSE UNDERGROUND UTILITIES. HOWEVER, LACKING EXCAVATION, THE EXACT LOCATION OF UNDERGROUND FEATURES CANNOT BE ACCURATELY, COMPLETELY, AND RELIABLY DEPICTED, WHERE ADDITIONAL OR MORE DETAILED INFORMATION IS REQUIRED, THE CLIENT IS ADVISED THAT EXCAVATION MAY BE REQUIRED.
 - ON SITE TOPOGRAPHY BASED UPON FIELD RUN SURVEY COMPLETED BY BOHLER ON FEBRUARY 24, 2021.

OWNER'S/DEVELOPER'S CERTIFICATION - GRADING
 I/WE CERTIFY THAT ALL GRADING ON THIS SITE WILL BE DONE IN ACCORDANCE WITH THE CURRENT GRADING REQUIREMENTS AS SET FORTH BY THE BALTIMORE COUNTY DEPARTMENT OF ENVIRONMENTAL PROTECTION AND SUSTAINABILITY AND WITH THE REQUIREMENTS SPECIFIED IN ARTICLE 33, TITLE 5 OF THE BALTIMORE COUNTY CODE.

SIGNATURE OF OWNER/DEVELOPER _____ TITLE _____ DATE _____
 PRINT NAME _____

OWNER/DEVELOPER
 TRADEPOINT DEVELOPMENT, LLC
 1600 SPARROWS POINT BLVD
 BALTIMORE, MD 21219
 CONTACT: MICHAEL BARRY
 PHONE: 443-649-5070

LEGEND

EXISTING NOTE	TYPICAL NOTE TEXT	PROPOSED NOTE
ON-SITE PROPERTY LINE / R.O.W. LINE	CONTOUR LINE	CONTOUR LINE
SPOT ELEVATIONS	SANITARY SEWER LINE	SANITARY SEWER LINE
UNDERGROUND WATER LINE	INDUSTRIAL WATER LINE	INDUSTRIAL WATER LINE
UNDERGROUND ELECTRIC LINE	UNDERGROUND GAS LINE	UNDERGROUND GAS LINE
OVERHEAD WIRE	UNDERGROUND TELEPHONE LINE	UNDERGROUND TELEPHONE LINE
STORM SEWER	SANITARY SEWER FORCE MAIN	SANITARY SEWER FORCE MAIN
LIMIT OF DISTURBANCE	CONCRETE CURB & GUTTER	CURB AND GUTTER
		SPILL CURB


STORMWATER MANAGEMENT PERMIT NOT REQUIRED


BALTIMORE COUNTY DEPARTMENT OF ENVIRONMENTAL PROTECTION AND SUSTAINABILITY
APPROVED FOR GRADING

DATE _____

- BALTIMORE COUNTY STANDARD GRADING PLAN NOTES**
- THE PROPOSED GRADING SHOWN ON THIS PLAN MEETS THE REQUIREMENTS SET FORTH BY BALTIMORE COUNTY DEPARTMENT OF ENVIRONMENTAL PROTECTION AND SUSTAINABILITY AND COMPLIES WITH ARTICLE 33, TITLE 5 OF THE BALTIMORE COUNTY CODE. HOWEVER, DUE TO BUILDING TYPES AND LAYOUT, SOME FIELD ADJUSTMENTS MAY BE REQUIRED. ALL CHANGES MUST COMPLY WITH THE ABOVE MENTIONED REQUIREMENTS.
 - ALL SWALES HAVE BEEN DESIGNED BY THE ENGINEER TO CONVEY RUNOFF ACCORDING TO BALTIMORE COUNTY DEPARTMENT OF PUBLIC WORKS DESIGN STANDARDS.
 - THERE SHALL BE NO CLEARING, GRADING, CONSTRUCTION OR DISTURBANCE OF VEGETATION IN THE FOREST BUFFER EASEMENT OR OTHER FOREST RETENTION AREAS, EXCEPT AS PERMITTED BY THE BALTIMORE COUNTY DEPARTMENT OF ENVIRONMENTAL PROTECTION AND SUSTAINABILITY.
 - STORMWATER MANAGEMENT HAS BEEN ADDRESSED THROUGH A PAYMENT OF A FEE-IN-LIEU TO THE BALTIMORE COUNTY STORMWATER MANAGEMENT FUND FOR 4.52 AC. OF IMPERVIOUS AREA BASED ON AN L.O.D. OF 6.16 ACRES.


LIMIT OF DISTURBANCE: 268,118 S.F. OR 6.16 AC.

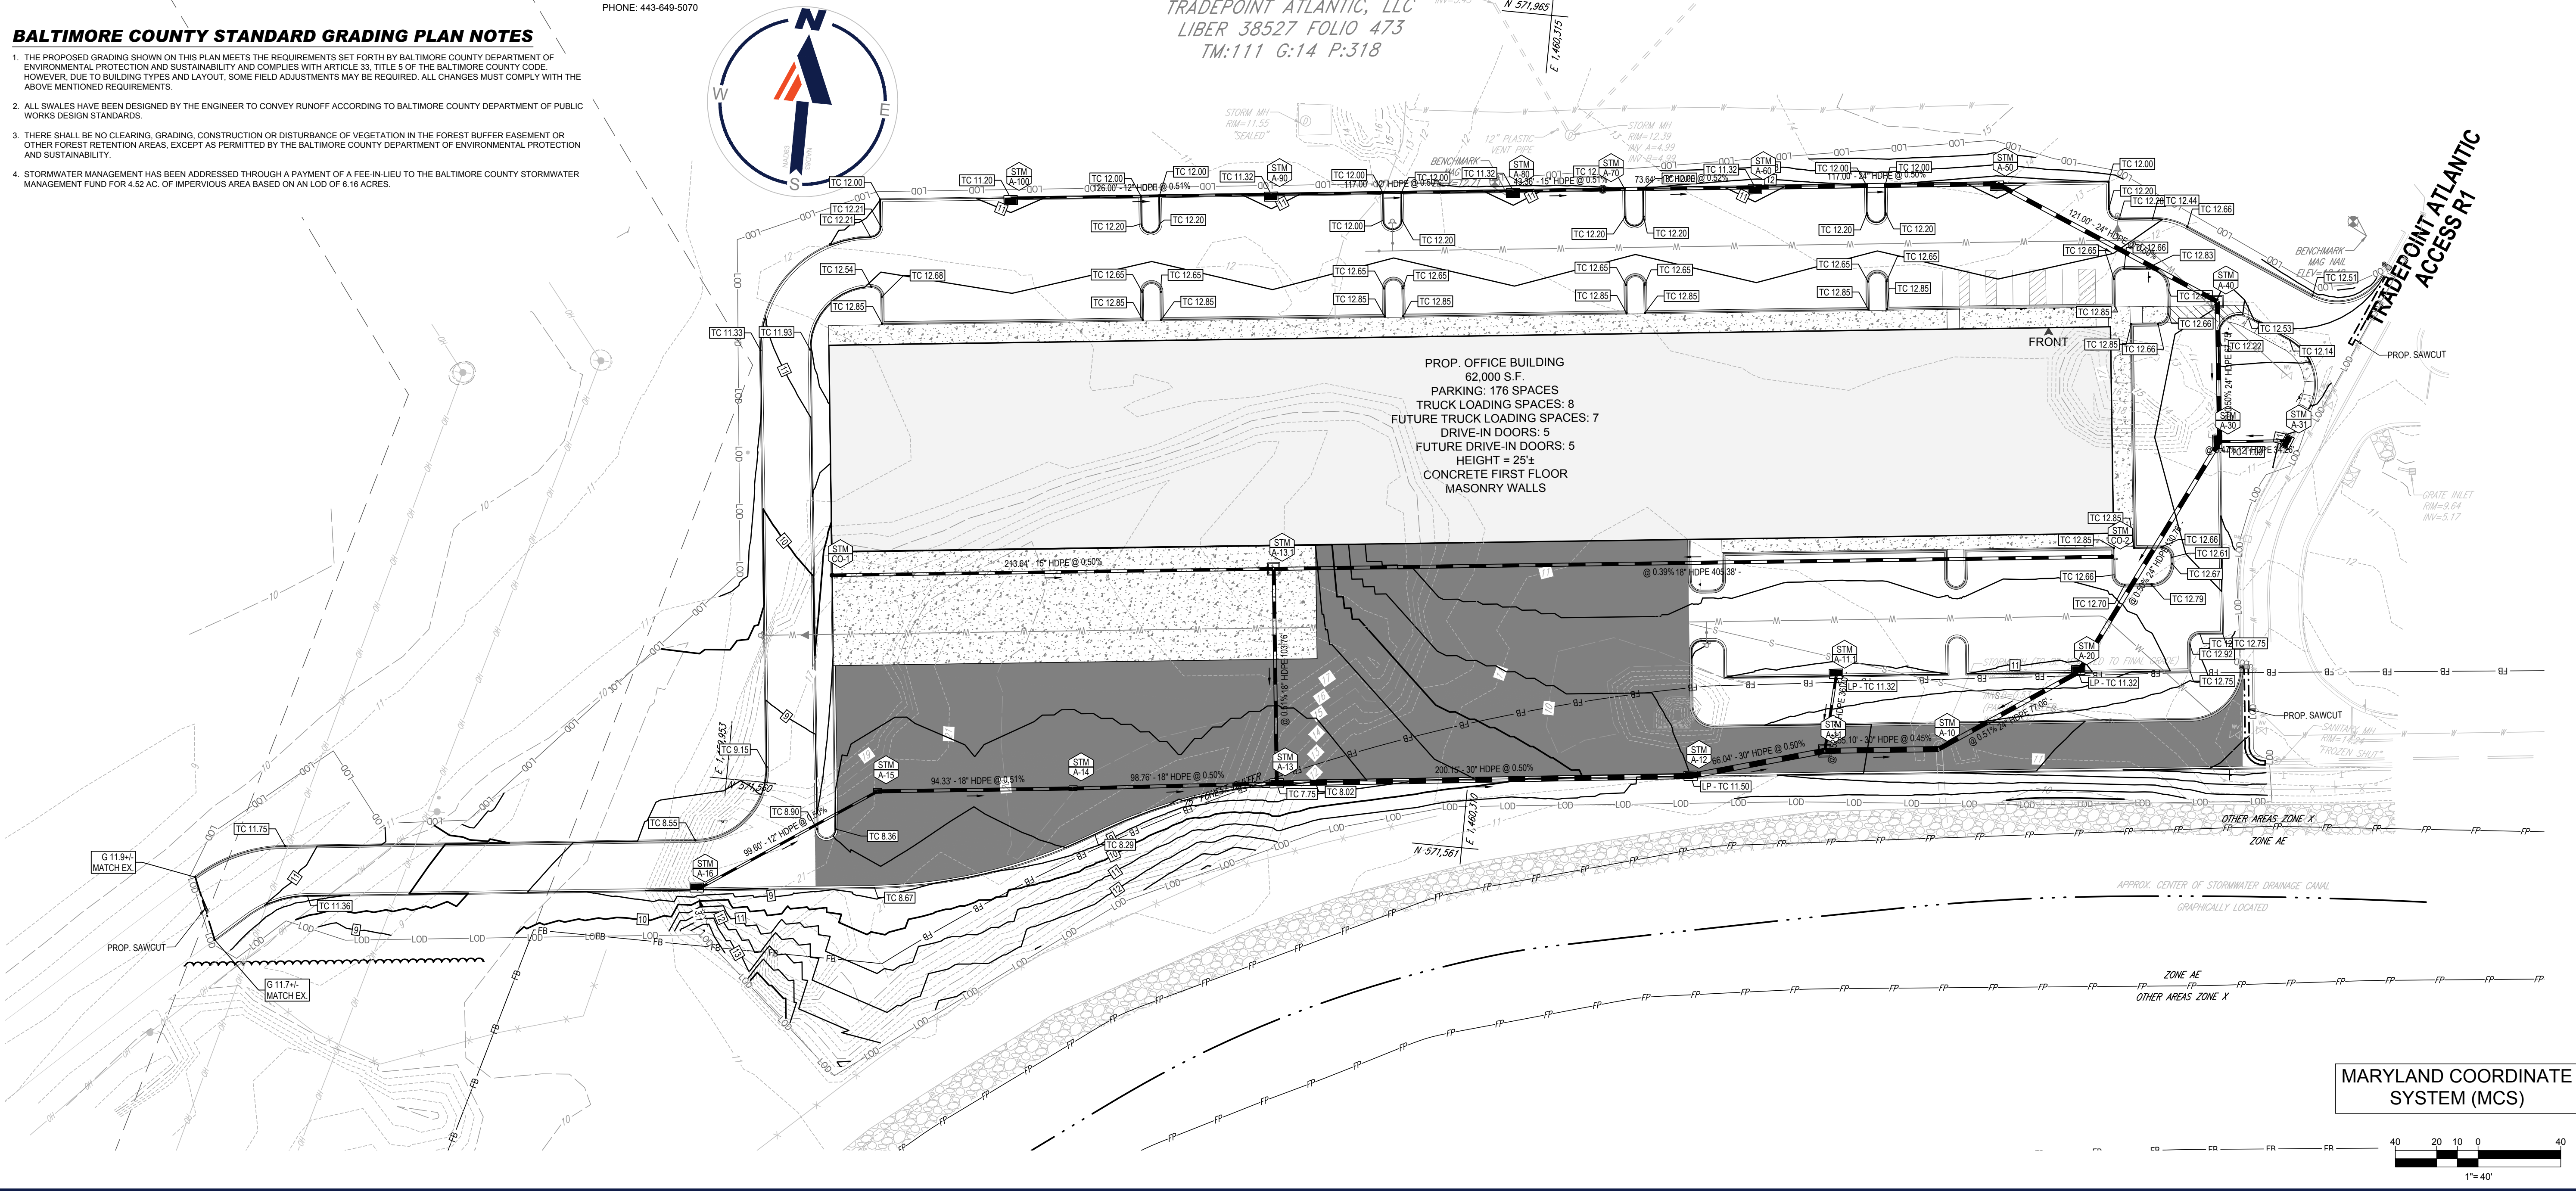

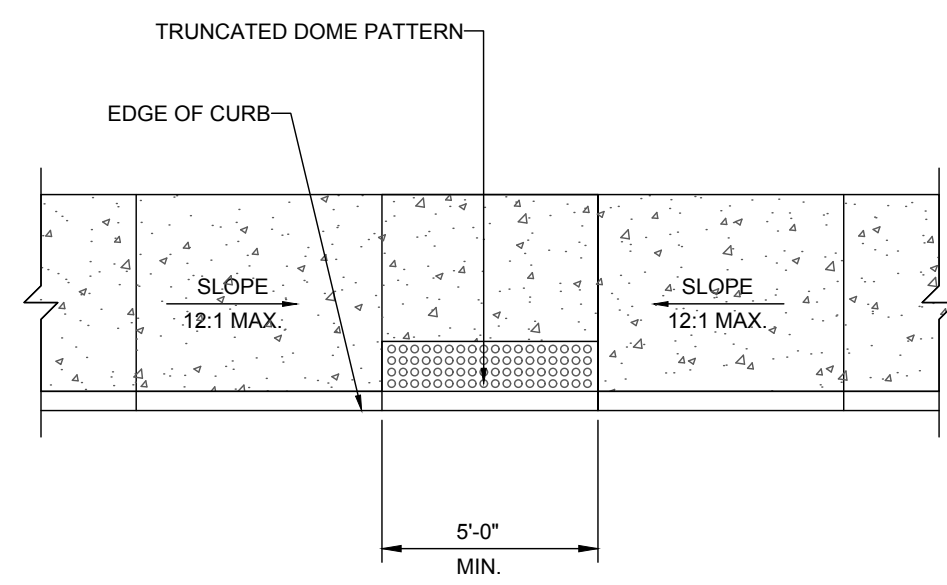


NOTE:
ADA ACCESSIBLE RAMP CONSTRUCTION SHALL CONFORM TO CURRENT ADA ACCESSIBLE GUIDELINES.

ADA ACCESSIBLE RAMP DETAIL
NOT TO SCALE

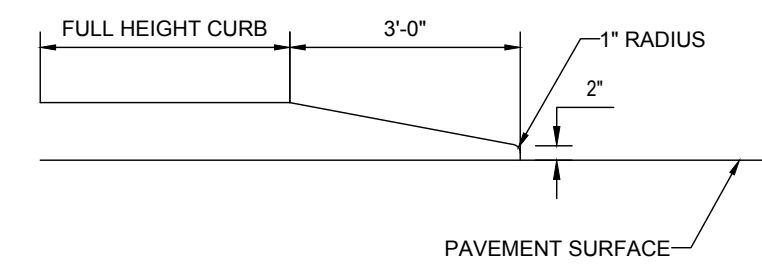


CURB TAPER DETAIL
NOT TO SCALE

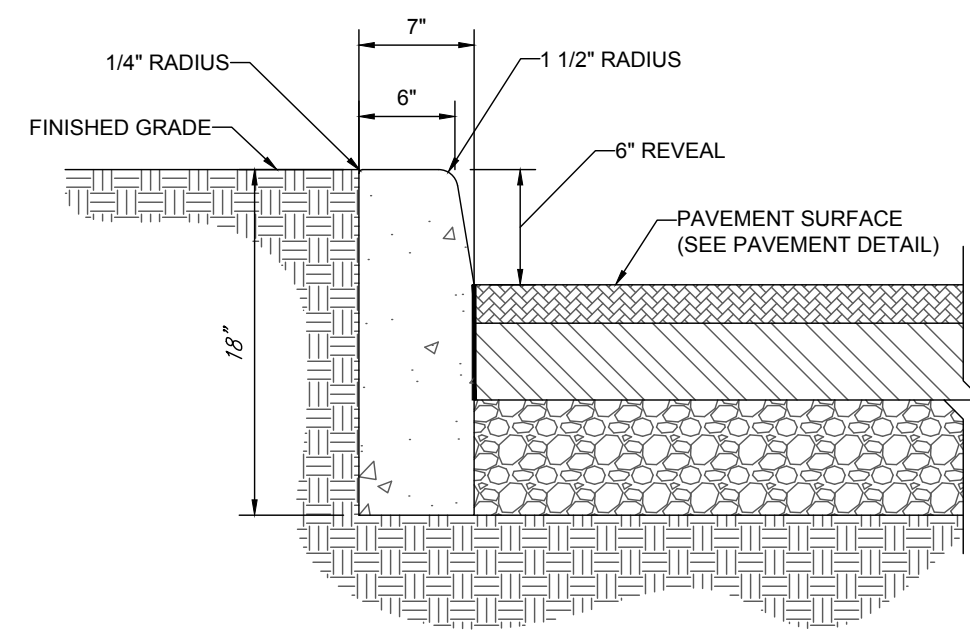


NOTES:
1. CONCRETE JOINTS TO BE INSTALLED AT 20' INTERVALS.
2. THIS ITEM MAY BE PRECAST OR CAST IN PLACE.
3. CONCRETE TO BE CLASS A3 IF CAST IN PLACE OR 4000 P.S.I. IF PRECAST.

HEADER CURB DETAIL
NOT TO SCALE

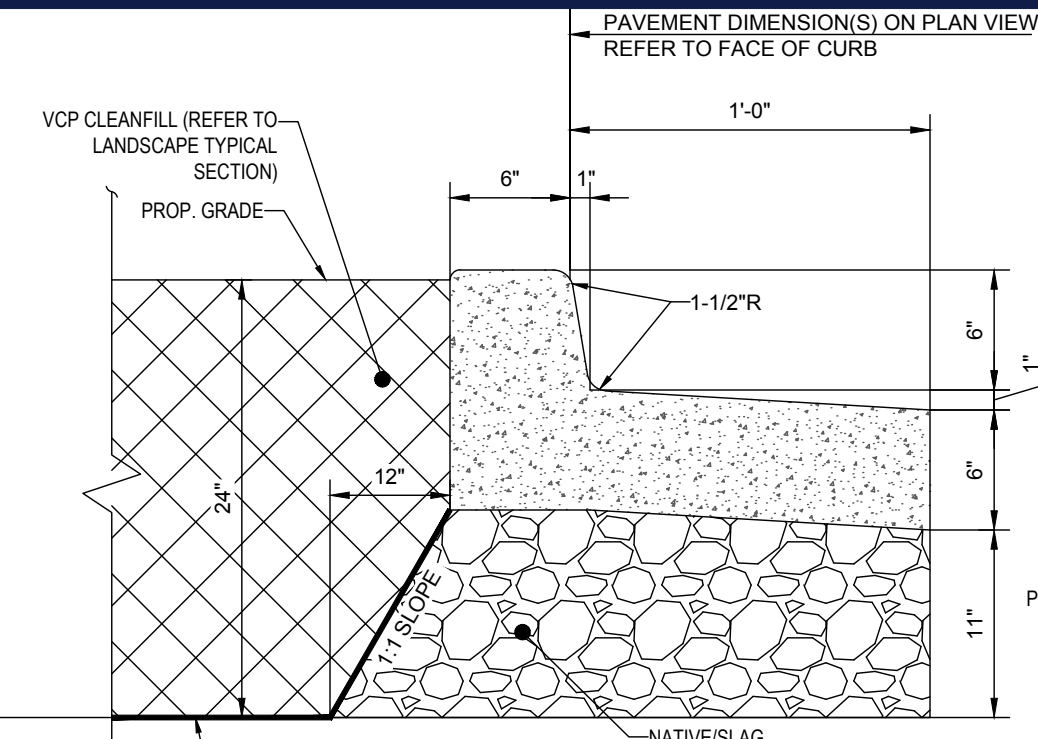


NOTES:
1. CONCRETE FOR CURBING SHALL HAVE A MINIMUM COMPRESSIVE STRENGTH OF 3,000 P.S.I. @ 28 DAYS.
2. CONSTRUCTION STAKING FOR CURB INSTALLATION SHALL BE REFERENCED (CUT OR FILL) TO THE TOP OF CURB.
3. AT CONTRACTOR'S OPTION, THE GUTTER THICKNESS MAY BE INCREASED AT THE EDGE OF PAVEMENT TO MAKE BOTTOM OF GUTTER CONTIGUOUS WITH BOTTOM OF ASPHALT PAVEMENT.
4. CONTRACTION JOINTS SHALL BE PLACED @ 10'-0" O.C. TOOLED 1/4" (±1/16") WIDE, 1" DEEP. EXPANSION JOINTS SHALL BE PLACED @ 40'-0" INTERVALS, MAXIMUM, AND ALL P.C.S.
5. GUTTER PAN SLOPE TO BE ADJUSTED WITHIN ACCESSIBLE PARKING SPACES TO MATCH SLOPE BETWEEN SPOT ELEVATIONS.

CONCRETE CURB & GUTTER DETAIL
NOT TO SCALE

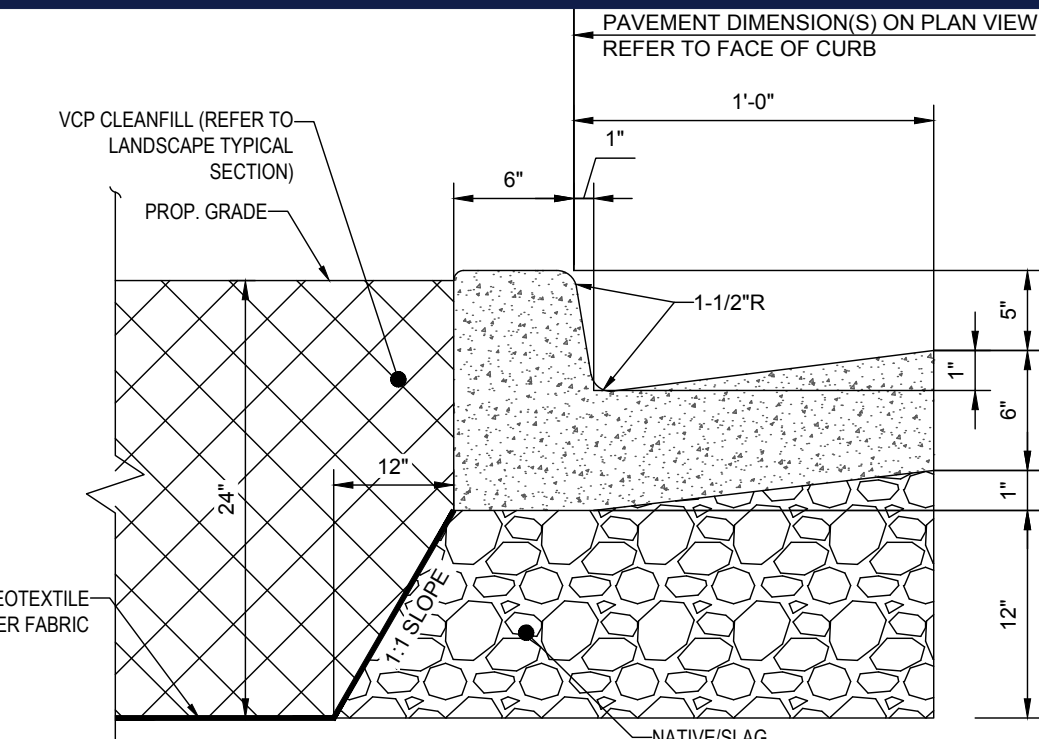


COLLECTOR CURB & GUTTER

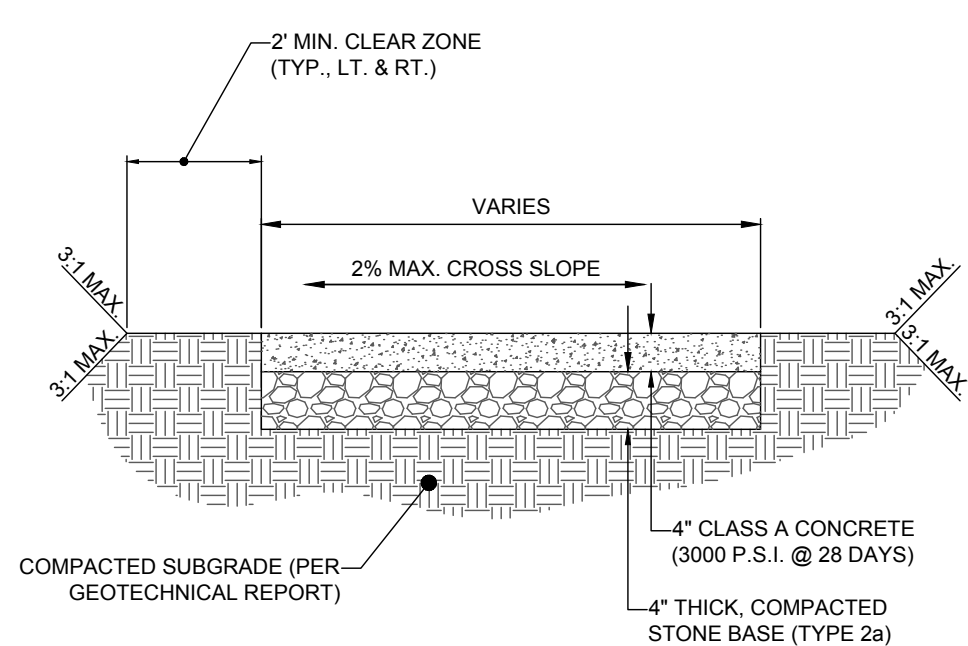


NOTE:
1. EXPANSION JOINTS 1/2" WIDE PREMOULDED BIT. MATERIAL SHALL BE INSTALLED AT 30' INTERVALS, CRACK CONTROL JOINTS TO BE SPACED AT INTERVALS EQUAL TO SIDEWALK WIDTH.

CONCRETE SIDEWALK DETAIL
NOT TO SCALE

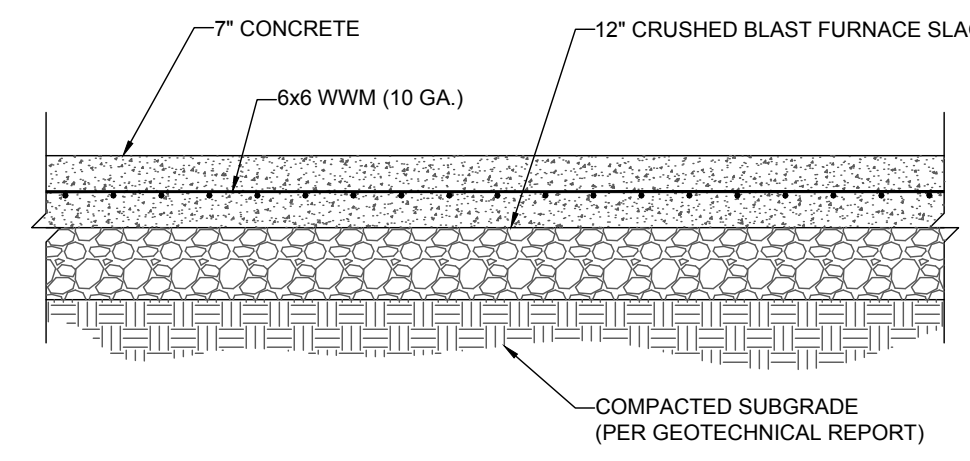


NOTE:
1. SECTION SHOWN IS BASED ON AN ANTICIPATED CBR OF 15 PER GEOTECHNICAL REPORT PREPARED BY HILLIS-CARNES ENGINEERING ASSOCIATES, ENTITLED: "GEOTECHNICAL ENGINEERING STUDY, TRADEPOINT ATLANTIC LOGISTICS CENTER VI, TRADEPOINT ATLANTIC, BALTIMORE COUNTY, MARYLAND", DATED JUNE 15, 2020 (PROJECT #20255A). FINAL DESIGN TO BE PROVIDED ONCE FINAL CBR'S ARE AVAILABLE ON COMPACTED SUB-BASE.

HEAVY DUTY CONCRETE SECTION
NOT TO SCALE

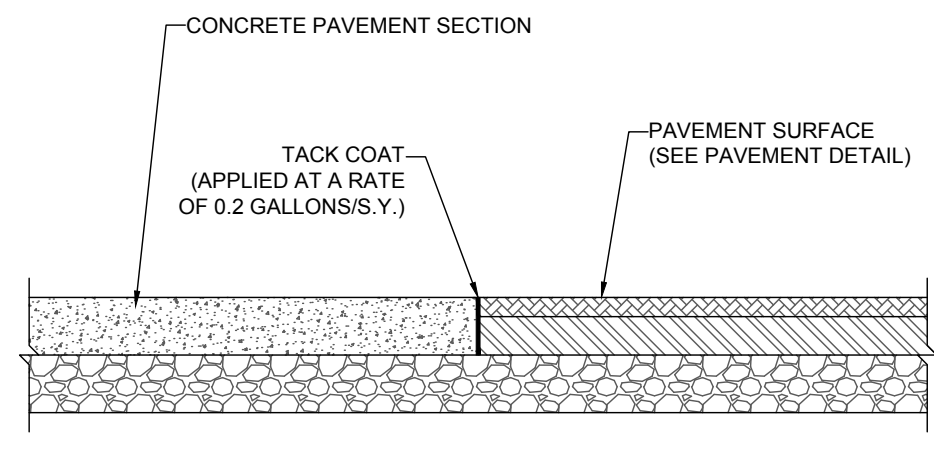


CONCRETE-TO-ASPHALT DETAIL
NOT TO SCALE

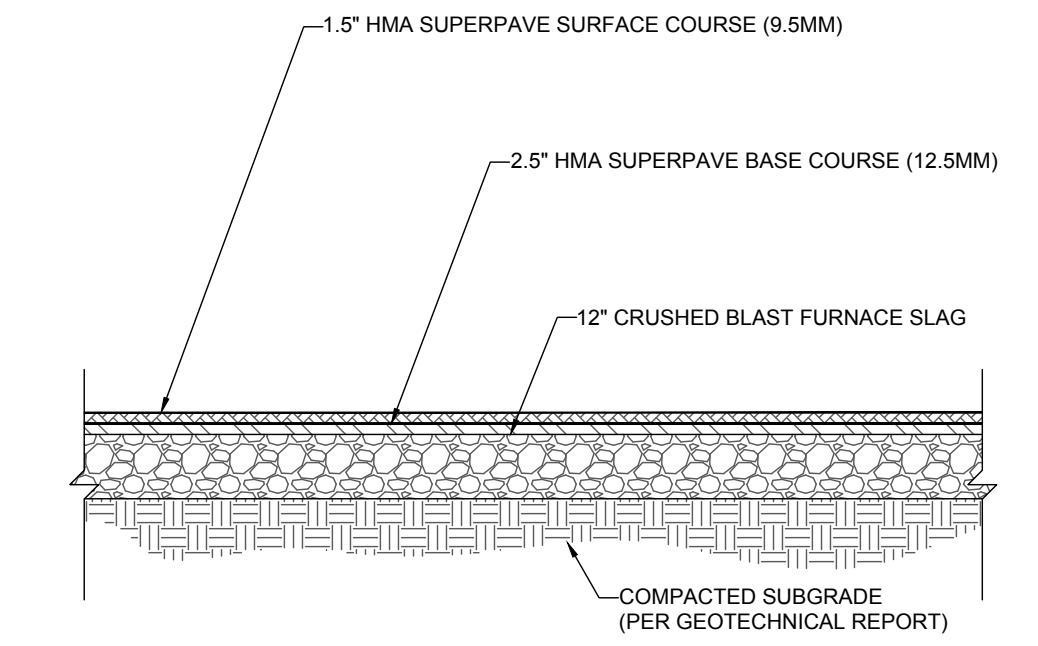


NOTE:
1. SECTION SHOWN IS BASED ON AN ANTICIPATED CBR OF 15 PER GEOTECHNICAL REPORT PREPARED BY HILLIS-CARNES ENGINEERING ASSOCIATES, ENTITLED: "GEOTECHNICAL ENGINEERING STUDY, TRADEPOINT ATLANTIC LOGISTICS CENTER VI, TRADEPOINT ATLANTIC, BALTIMORE COUNTY, MARYLAND", DATED JUNE 15, 2020 (PROJECT #20255A). FINAL DESIGN TO BE PROVIDED ONCE FINAL CBR'S ARE AVAILABLE ON COMPACTED SUB-BASE.

STANDARD DUTY ASPHALT PAVEMENT SECTION
NOT TO SCALE

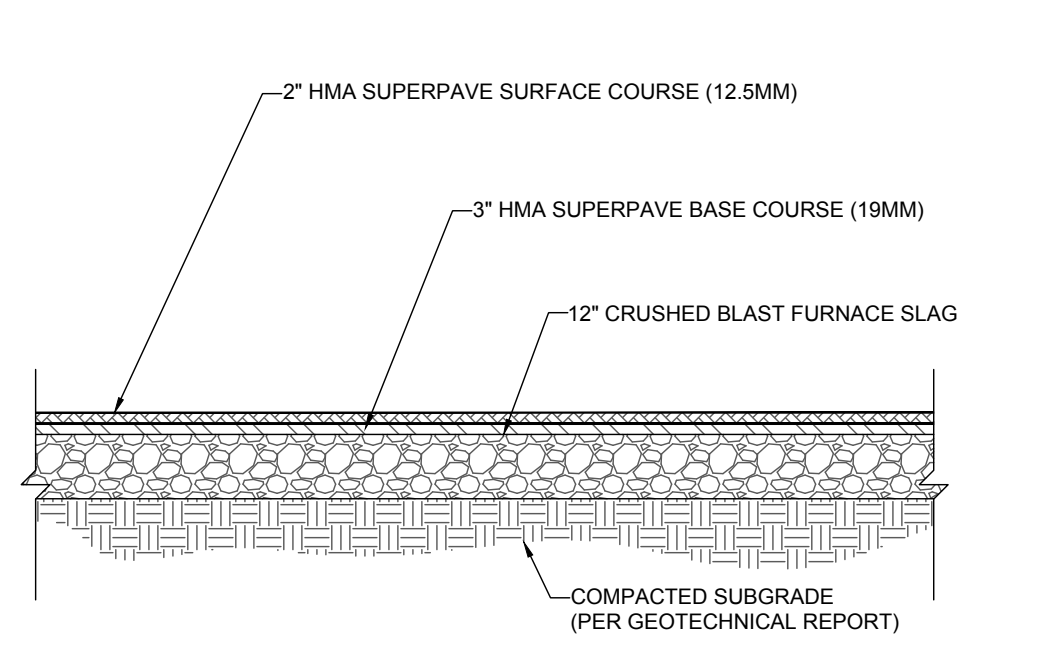


NOTE:
1. SECTION SHOWN IS BASED ON AN ANTICIPATED CBR OF 15 PER GEOTECHNICAL REPORT PREPARED BY HILLIS-CARNES ENGINEERING ASSOCIATES, ENTITLED: "GEOTECHNICAL ENGINEERING STUDY, TRADEPOINT ATLANTIC LOGISTICS CENTER VI, TRADEPOINT ATLANTIC, BALTIMORE COUNTY, MARYLAND", DATED JUNE 15, 2020 (PROJECT #20255A). FINAL DESIGN TO BE PROVIDED ONCE FINAL CBR'S ARE AVAILABLE ON COMPACTED SUB-BASE.

HEAVY DUTY ASPHALT PAVEMENT SECTION
NOT TO SCALE

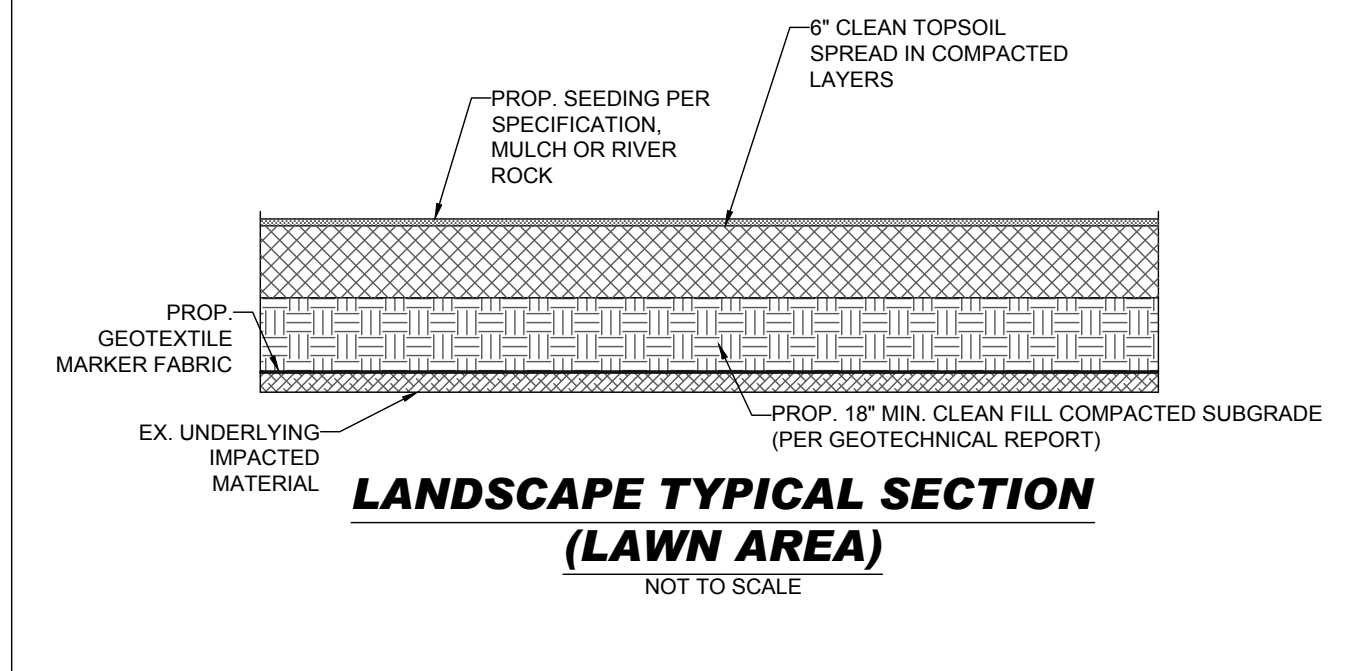

LANDSCAPE TYPICAL SECTION (LAWN AREA)
NOT TO SCALE

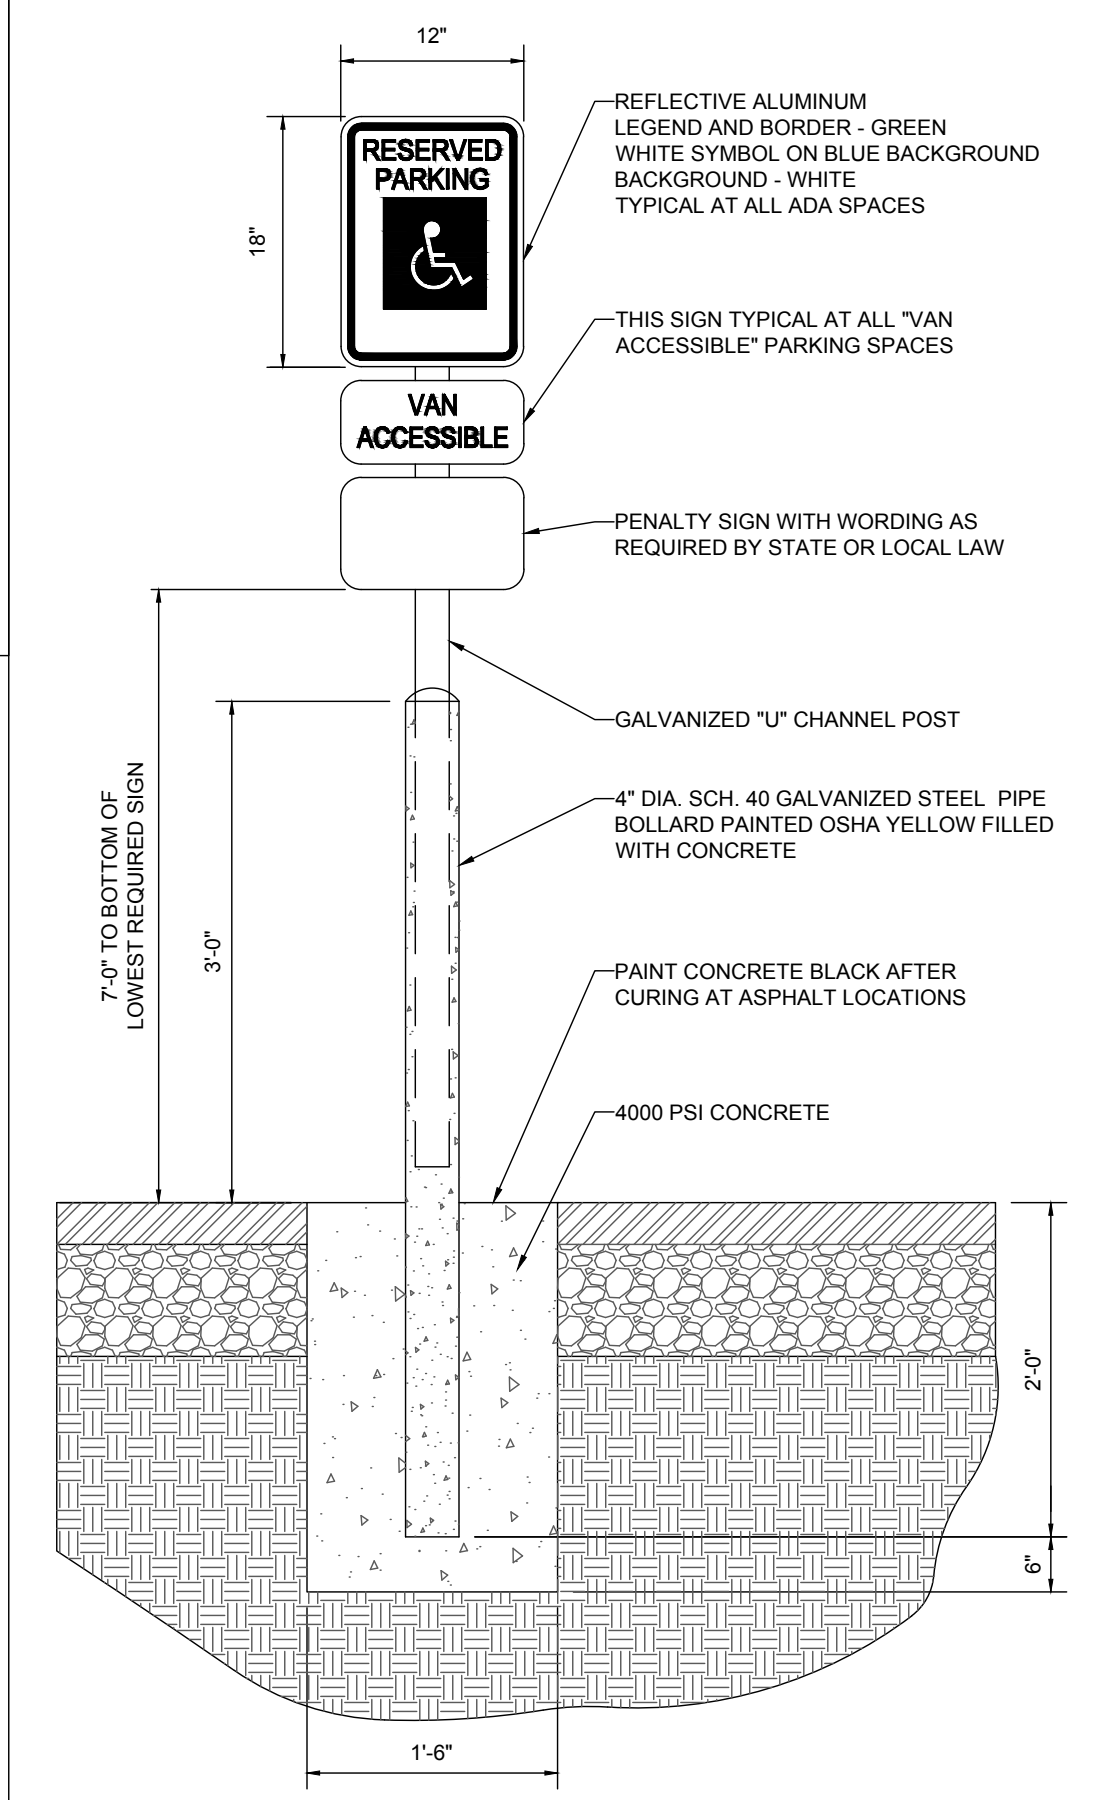

NOTE:
ONE AT EACH ADA SPACE. WHERE ADA SPACES FACE EACH OTHER WITHOUT WALKWAY, THERE SHALL BE ONE POST WITH SIGNS MOUNTED BOTH SIDES

BOLLARD MOUNTED ADA PARKING SIGN DETAIL
NOT TO SCALE

BOHLER
SITE CIVIL AND CONSULTING ENGINEERING
PROGRAM MANAGEMENT
LANDSCAPE ARCHITECTURE
SUSTAINABLE DESIGN
PERMITTING SERVICES
TRANSPORTATION SERVICES

REVISIONS			
REV	DATE	COMMENT	DRAWN BY / CHECKED BY

811
Know what's below.
Call before you dig.
ALWAYS CALL 811
It's fast. It's free. It's the law.

NOT APPROVED FOR CONSTRUCTION

PROJECT No.: MD16206636
DRAWN BY: JHS
CHECKED BY: MUG
DATE: 3/19/2021
CAD ID: MD16206636-SDP-0

FLEX BUILDING
FOR
TRADEPOINT ATLANTIC
6995 BETHLEHEM BOULEVARD
BALTIMORE, MD 21219
TM 111, GRID 14, PARCEL 318
ELECTION DISTRICT 15
COUNCILMANIC DISTRICT 7
BALTIMORE COUNTY

BOHLER
901 DULANEY VALLEY ROAD, SUITE 801
TOWSON, MARYLAND 21204
Phone: (410) 821-7900
Fax: (410) 821-7987
MD@BohlerEng.com

M.J. GESELL
PROFESSIONAL ENGINEER
MARYLAND LICENSE # 44097
PROFESSIONAL CERTIFICATION
I, MICHAEL J. GESELL, HEREBY CERTIFY THAT THESE DOCUMENTS WERE PREPARED OR APPROVED BY ME, AND THAT I AM A DULY LICENSED PROFESSIONAL ENGINEER UNDER THE LAWS OF THE STATE OF MARYLAND. LICENSE NO 44097, EXPIRATION DATE: 6/30/21

SHEET TITLE:
CONSTRUCTION DETAILS
SHEET NUMBER:
C-901
ORG. DATE - 3/19/2021

H:\16\MD16206636\DRAWINGS\PLAN SETS\CONSTRUCTION DOCUMENTS\MD16206636-SDP-0-1-LAYOUT-C-901-CONSTRUCTION DETAILS

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APPENDIX B

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Mirafi® 140N



Mirafi® 140N is a nonwoven geotextile composed of polypropylene fibers, which are formed into a stable network such that the fibers retain their relative position. Mirafi® 140N is inert to biological degradation and resists naturally encountered chemicals, alkalis, and acids. Mirafi® 140N meets AASHTO M288 Class 3 for Elongation > 50%.

TenCate Geosynthetics Americas Laboratories are accredited by Geosynthetic Accreditation Institute – Laboratory Accreditation Program ([GAI-LAP](#)). [NTPEP Listed](#)

Mechanical Properties	Test Method	Unit	Minimum Average Roll Value	
			MD	CD
Grab Tensile Strength	ASTM D4632	lbs (N)	120 (534)	120 (534)
Grab Tensile Elongation	ASTM D4632	%	50	50
Trapezoid Tear Strength	ASTM D4533	lbs (N)	50 (223)	50 (223)
CBR Puncture Strength	ASTM D6241	lbs (N)	310 (1380)	
			Maximum Opening Size	
Apparent Opening Size (AOS)	ASTM D4751	U.S. Sieve (mm)	70 (0.212)	
			Minimum Roll Value	
Permittivity	ASTM D4491	sec ⁻¹	1.7	
Flow Rate	ASTM D4491	gal/min/ft ² (l/min/m ²)	135 (5500)	
			Minimum Test Value	
UV Resistance (at 500 hours)	ASTM D4355	% strength retained	70	

Physical Properties	Unit	Roll Sizes	
Roll Dimensions (width x length)	ft (m)	12.5 x 360 (3.8 x 110)	15 x 360 (4.5 x 110)
Roll Area	yd ² (m ²)	500 (418)	600 (502)

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Fax 706 693 4400
www.tencate.com



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